

Addendum No. 2
Page 1 of 6

DATE: February 26, 2016

Joliet Junior College 1215 Houbolt Road Joliet, IL 60431

**TO:** Prospective Respondents

**SUBJECT:** Addendum No. 2

**PROJECT NAME:** Renaissance Center Interior Renovations

**IJC PROJECT NO.:** B16008

This Addendum forms a part of the Bidding and Contract Documents and modifies the original bidding document as posted on the JJC website. *Acknowledge receipt of this addendum as instructed on the last page.* FAILURE TO DO SO MAY SUBJECT BIDDER TO DISOUALIFICATION.

### **ADDENDA TO THE PROJECT MANUAL:**

1. Section 12 24 13 – ROLLER WINDOW SHADES

A. **REMOVE** article 1.3-B-1 in its entirety.

2. Section 23 05 05 - HVAC DEMOLITION FOR REMODELING

A. <u>ADD</u> the following as paragraph 3.3J

Properly reclaim and dispose of all refrigerant in demolished equipment and as required for extension of existing equipment.

### **ADDENDA TO THE DRAWINGS:**

- 1. **Architectural Drawings** 
  - A. **AD1.11, AD2.11, AD9.01, A9.01, A9.02, A9.03, A11.21**: **REPLACE** sheets in their entirety with those attached.
  - B. Sheet AD1.21: **REVISE** detail 1 per attached **sketch AD121-01**.
  - C. Sheet AD2.21: **REVISE** detail 1 per attached **sketch AD221-01**.
  - D. Sheet AD4.01: **REVISE** detail 1 note to read "EXISTING SCUPPER TO REMAIN. EXISTING DOWNSPOUT TO BE REMOVED AND REPLACED SEE NEW WORK ELEVATION AND CIVIL DRAWINGS."

- E. All Demolition Sheets Demo Floor Plan Referenced Notes: **REVISE** note W13 to read "REMOVE WALL OR PORTION OF WALL UNDER ALTERNATE BID #1. SHORE AND SUPPORT WALL STRUCTURE AND SECOND FLOOR STRUCTURE AS NECESSARY."
- F. Sheet A1.21: **REVISE** detail 1 per attached **sketch A121-01**.
- G. Sheet A6.02: **REVISE** detail 1 note to read "REUSE EXISTING BLOCKING OR PROVIDE NEW BLOCKING AS REQUIRED."
- H. Sheet A7.52: **REVISE** detail 10 note to read "REUSE EXISTING BLOCKING OR PROVIDE NEW BLOCKING AS REQUIRED."
- I. Sheet A8.91: **REVISE** detail 5 note to read "6" COLD-FORMED STUDS TO ANCHOR OPERABLE PARTITION TO EXISTING STRUCTURE ABOVE."
- J. Sheet A10.00: **REVISE** detail 2 per attached **sketch A1000-01**.
- K. Sheet A11.11: **REVISE** detail 1 per attached **sketch A1111-01**.

### 2. **Mechanical Drawings**

- A. Sheet MD1.00: <u>ADD</u> note "DISCONNECT AND REMOVE SECTION OF STEAM AND CONDENSATE PIPING FOR NEW BRANCH CONNECTION." for new RAD-1030.3 on north wall of Room 1030.
- B. Sheets MD1.10: **REMOVE** three radiators located on west wall and one radiator in middle on north wall of HOSPITALITY (FOUNDATION ROOM).
- C. Sheet M2.00: <u>ADD</u> new 1-1/4" steam and 3/4" low pressure condensate piping to RAD-1030.3 in Room 1030.
- D. Sheet M2.10: **REMOVE** radiator on west wall. **MODIFY** tags for radiators located in CLASSROOM 1030. Refer to M2.10 for additional information.
- E. Sheet M5.00: Condensing Unit Schedule: **MODIFY** electrical information for CU-1. Radiation Schedule: **MODIFY** RAD-1030.1, RAD-1030.2 & RAD-1030.3. **REMOVE** RAD-1030.4, RAD-1030.5 & RAD-1030.6. Grilles, Registers & Diffusers: **MODIFY** RG-2. Refer to M5.00 for additional information.

### 3. **Plumbing Drawings**

- A. Sheet P1.10: **MODIFY** Plumbing fixture tags in MEN'S TOILET ROOM 1112. Add plumbing piping to MB-1 on second floor STORAGE ROOM 2019. Refer to P1.10 for additional information.
- B. Sheet P1.20: **ADD** MB-1 and WH-1 to north-west corner of STORAGE ROOM 2019. Tie in vent piping to riser up thru roof.

### 4. **Electrical Drawings**

### A. Sheet E1.10:

- 1) **REVISE** fixture locations to match Architect's RCP.
- 2) **REVISE** F1 in ELEVATOR MACHINE ROOM 1043 to normal branch luminaire (no shade), and modify circuit from "LSC1L1-20" to "R1L1-20".

### B. Sheet E1.20:

- 1) **REVISE** fixture locations to match Architect's RCP in STORAGE 2019.
- 2) <u>ADD</u> keynote #6 to read: ALL ELECTRICAL EQUIPMENT ON NORTH WALL OF STORAGE 2019 SHALL NOT BE INSTALLED WITHIN 4'-0" OF MOP BASIN.
- 3) ADD keynote #6 to room STORAGE 2019.

### C. Sheet E2.10

- 1) **REVISE** receptacle circuit in ELEVATOR MACHINE ROOM 1043.
- 2) **REVISE** receptacle location in INTERROGATION ROOM 1026.
- 3) **REVISE** receptacle location in INTERROGATION ROOM 1027.
- 4) **REVISE** receptacle location in INTERROGATION ROOM 1028.
- 5) **REVISE** circuit for receptacle along column line 8 in CORRIDOR 1116.
- 6) **REVISE** circuit for receptacle along column line 8 in CORRIDOR 1126.
- 7) ADD circuit to electrical connection for CH-2 in VESTIBULE 1125.
- 8) ADD circuit to electrical connection for CH-1 in VESTIBULE 1119.
- 9)**ADD** electrical connection for hand dryer, sink, and toilet in UNI-SEX TOILET 1127. **REVISE** receptacle location to north wall.
- 10) <u>ADD</u> electrical connection for hand dryer and sink in LACTATION ROOM 1128. **REVISE** location and mounting height of receptacle on west wall.
- 11) **REVISE** circuit for WH-1 in JANITOR 1117.

### D. Sheet E2.20:

- 1) **REVISE** circuit for receptacle along column line K in BAR 2110 from "R2L3-6" to "EOR0L1-1".
- 2)<u>ADD</u> electrical connection for WH-1 in STORAGE 2019 and circuit to "DP-R0H1-6"
- 3) **REVISE** duplex receptacles on north wall and west wall to GFI duplex receptacles.
- 4) REVISE location of BALLROOM LIGHITNG DIMMING PANEL and PANEL 'R2L3'.
- 5)<u>ADD</u> keynote #5 to read: ALL ELECTRICAL EQUIPMENT ON NORTH WALL OF STORAGE 2019 SHALL NOT BE INSTALLED WITHIN 4'-0" OF MOP BASIN.
- 6) ADD keynote #5 to room STORAGE 2019.

### E. Sheet E2.30:

- 1) **REVISE** location of electrical connection for refrigeration rack to match Architect's location shown on A3.01. Add keynote #3 to electrical connection.
- 2) ADD keynote #3 to read: CONNECT REFRIGERATION RACK TO PANEL 'EQC3L1' LOCATED IN ELECTRICAL CLOSET 3103 IN CITY CENTER. PROVIDE A NEW 80A/3P CIRCUIT BREAKER. USE 3#4 AND 1#8 GND IN 1" C. MATCH EXISTING TYPE AND RATINGS.

### F. Sheet E4.00:

1)<u>ADD</u> two (2) 25A/3P circuit breakers to "DP-R0H1" for two (2) WH-1. Feeders shall be 3#12 & 1#12 in <sup>3</sup>/<sub>4</sub>" C. Add keynote #5 to both breakers.

- 2) ADD keynote #5 to read: PROVIDE LOCKABLE CIRCUIT BREAKER.
- 3) ADD two (2) 50A/3P circuit breakers to "DP-R0H1" as spares.
- 4) **REVISE** "DP-R0H1-1" feeder conduit size to 3/4" C.
- 5) ADD two (2) 200A/3P circuit breakers to "DP-R0L1" as spares.

### G. Sheet E6.10:

- 1) ADD panel note to all panels stating "UNLESS NOTED OTHERWISE, ALL CIRCUITS SHALL HAVE 2#12 & 1#12 GND IN 3/4" C. USE #10 FOR CIRCUIT HOME RUN LENGTHS OVER 75 FEET."
- 2) **REVISE** circuit breaker size of "R1L1-21" to a 15A/1P.
- 3) **REVISE** circuit breaker size of "R1L2-19" to a 15A/1P.
- 4) <u>ADD</u> eight (8) 20A/1P circuit breakers as spares on panels "R1L3", "R1L1", and "R2L2".
- 5) ADD five (5) 20A/1P circuit breakers as spares on panel "R0L1" and "R2L3".
- 6) ADD two (2) 20A/1P circuit breakers as spares on panel "R1L2".

### H. Sheet E6.11:

- 1) ADD panel note to "EQC1H1" AND "EQR0L1" stating "UNLESS NOTED OTHERWISE, ALL CIRCUITS SHALL HAVE 2#12 & 1#12 GND IN 3/4" C. USE #10 FOR CIRCUIT HOME RUN LENGTHS OVER 75 FEET."
- 2) <u>ADD</u> panel note to "EQC1H1" stating "EXISTING PANEL CONTRACTOR SHALL FIELD VERIFY ALL PANEL CHARACTERISTICS AND EXISTING CIRCUIT BREAKERS AND LOADS."
- 3) ADD nine (9) 20A/1P circuit breakers as spares on panel "EQR0L1".
- 4) ADD 20A/1P circuit breaker to "EQR0L1-1".

### 5. **Technology Drawings**

- A. Sheet T1.10:
  - 1) ADD Card Reader rough-in and wiring to Storage room 1044.
  - 2) ADD Card Reader rough-in and wiring to Elevator Machine Room 1043.
  - 3) ADD Card Reader rough-in and wiring to Corridor 1129.
  - 4) ADD Card Reader rough-in and wiring to Storage Room 1025.
  - 5) ADD Card Reader rough-in and wiring to Storage Room 1045.
  - 6) **ADD** Card Reader rough-in and wiring to Kitchen Storage 1040.
- B. Sheet T1.20
  - 1) ADD Card Reader rough-in and wiring to Ballroom 2020 southern most door.
- C. Sheet T4.00
  - 1) **REVISE** CONTROLLED SECURITY SCHEME (CSS) TYPE SCHEDULE
- D. Sheet T5.00
  - 1) **REVISE** GENERAL TECHNOLOGY EQUIPMENT SCHEDULE

### 6. **Food Service**

A. **FSE 1, FSE 2, FSE 3, FSE 4, FSE 5**: <u>ADD</u> the attached sheets to the drawing set.

### **OUESTIONS SUBMITTED:**

### **Scope and Bidding Requirements**

1. FSE 1-5 drawings are missing from the plan set but are included in the table of contents. Please provide these drawings.

The drawings are provided as part of Addendum 2.

### **End of Addendum #2**

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### **Attachments:**


- 1. Drawings:
  - A. Architectural: AD1.11, AD121-01, AD2.11, AD221-01, AD9.01, A121-01, A9.01, A9.02, A9.03, A1000-01, A1111-01, A11.21
  - B. Mechanical: M2.10, M5.00
  - C. Plumbing: P1.10
  - D. Electrical: E2.10
  - E. Technology: T1.10, T1.20, T4.00, T5.00
  - F. Food Service: FSE 1, FSE 2, FSE 3, FSE 4, FSE 5



### Addendum No. 2 Page 6 of 6

DATE: February 26, 2016

TO: SUBJECT: PROJECT NAME: JJC PROJECT NO.:	Prospective Respondents Addendum No. 2 Renaissance Center Interior Renovations B16008
document as posted o	s a part of the Bidding and Contract Documents and modifies the original bidding on the JJC website. <i>Acknowledge receipt of this addendum as instructed on the</i> TO DO SO MAY SUBJECT BIDDER TO DISQUALIFICATION.
Issued by:	
Janice Reedus Director of Business & Joliet Junior College 815.280.6643	& Auxiliary Services
I acknowledge receipt	of Addendum #2
Company Name	
Printed Name	
Title	
Signature	

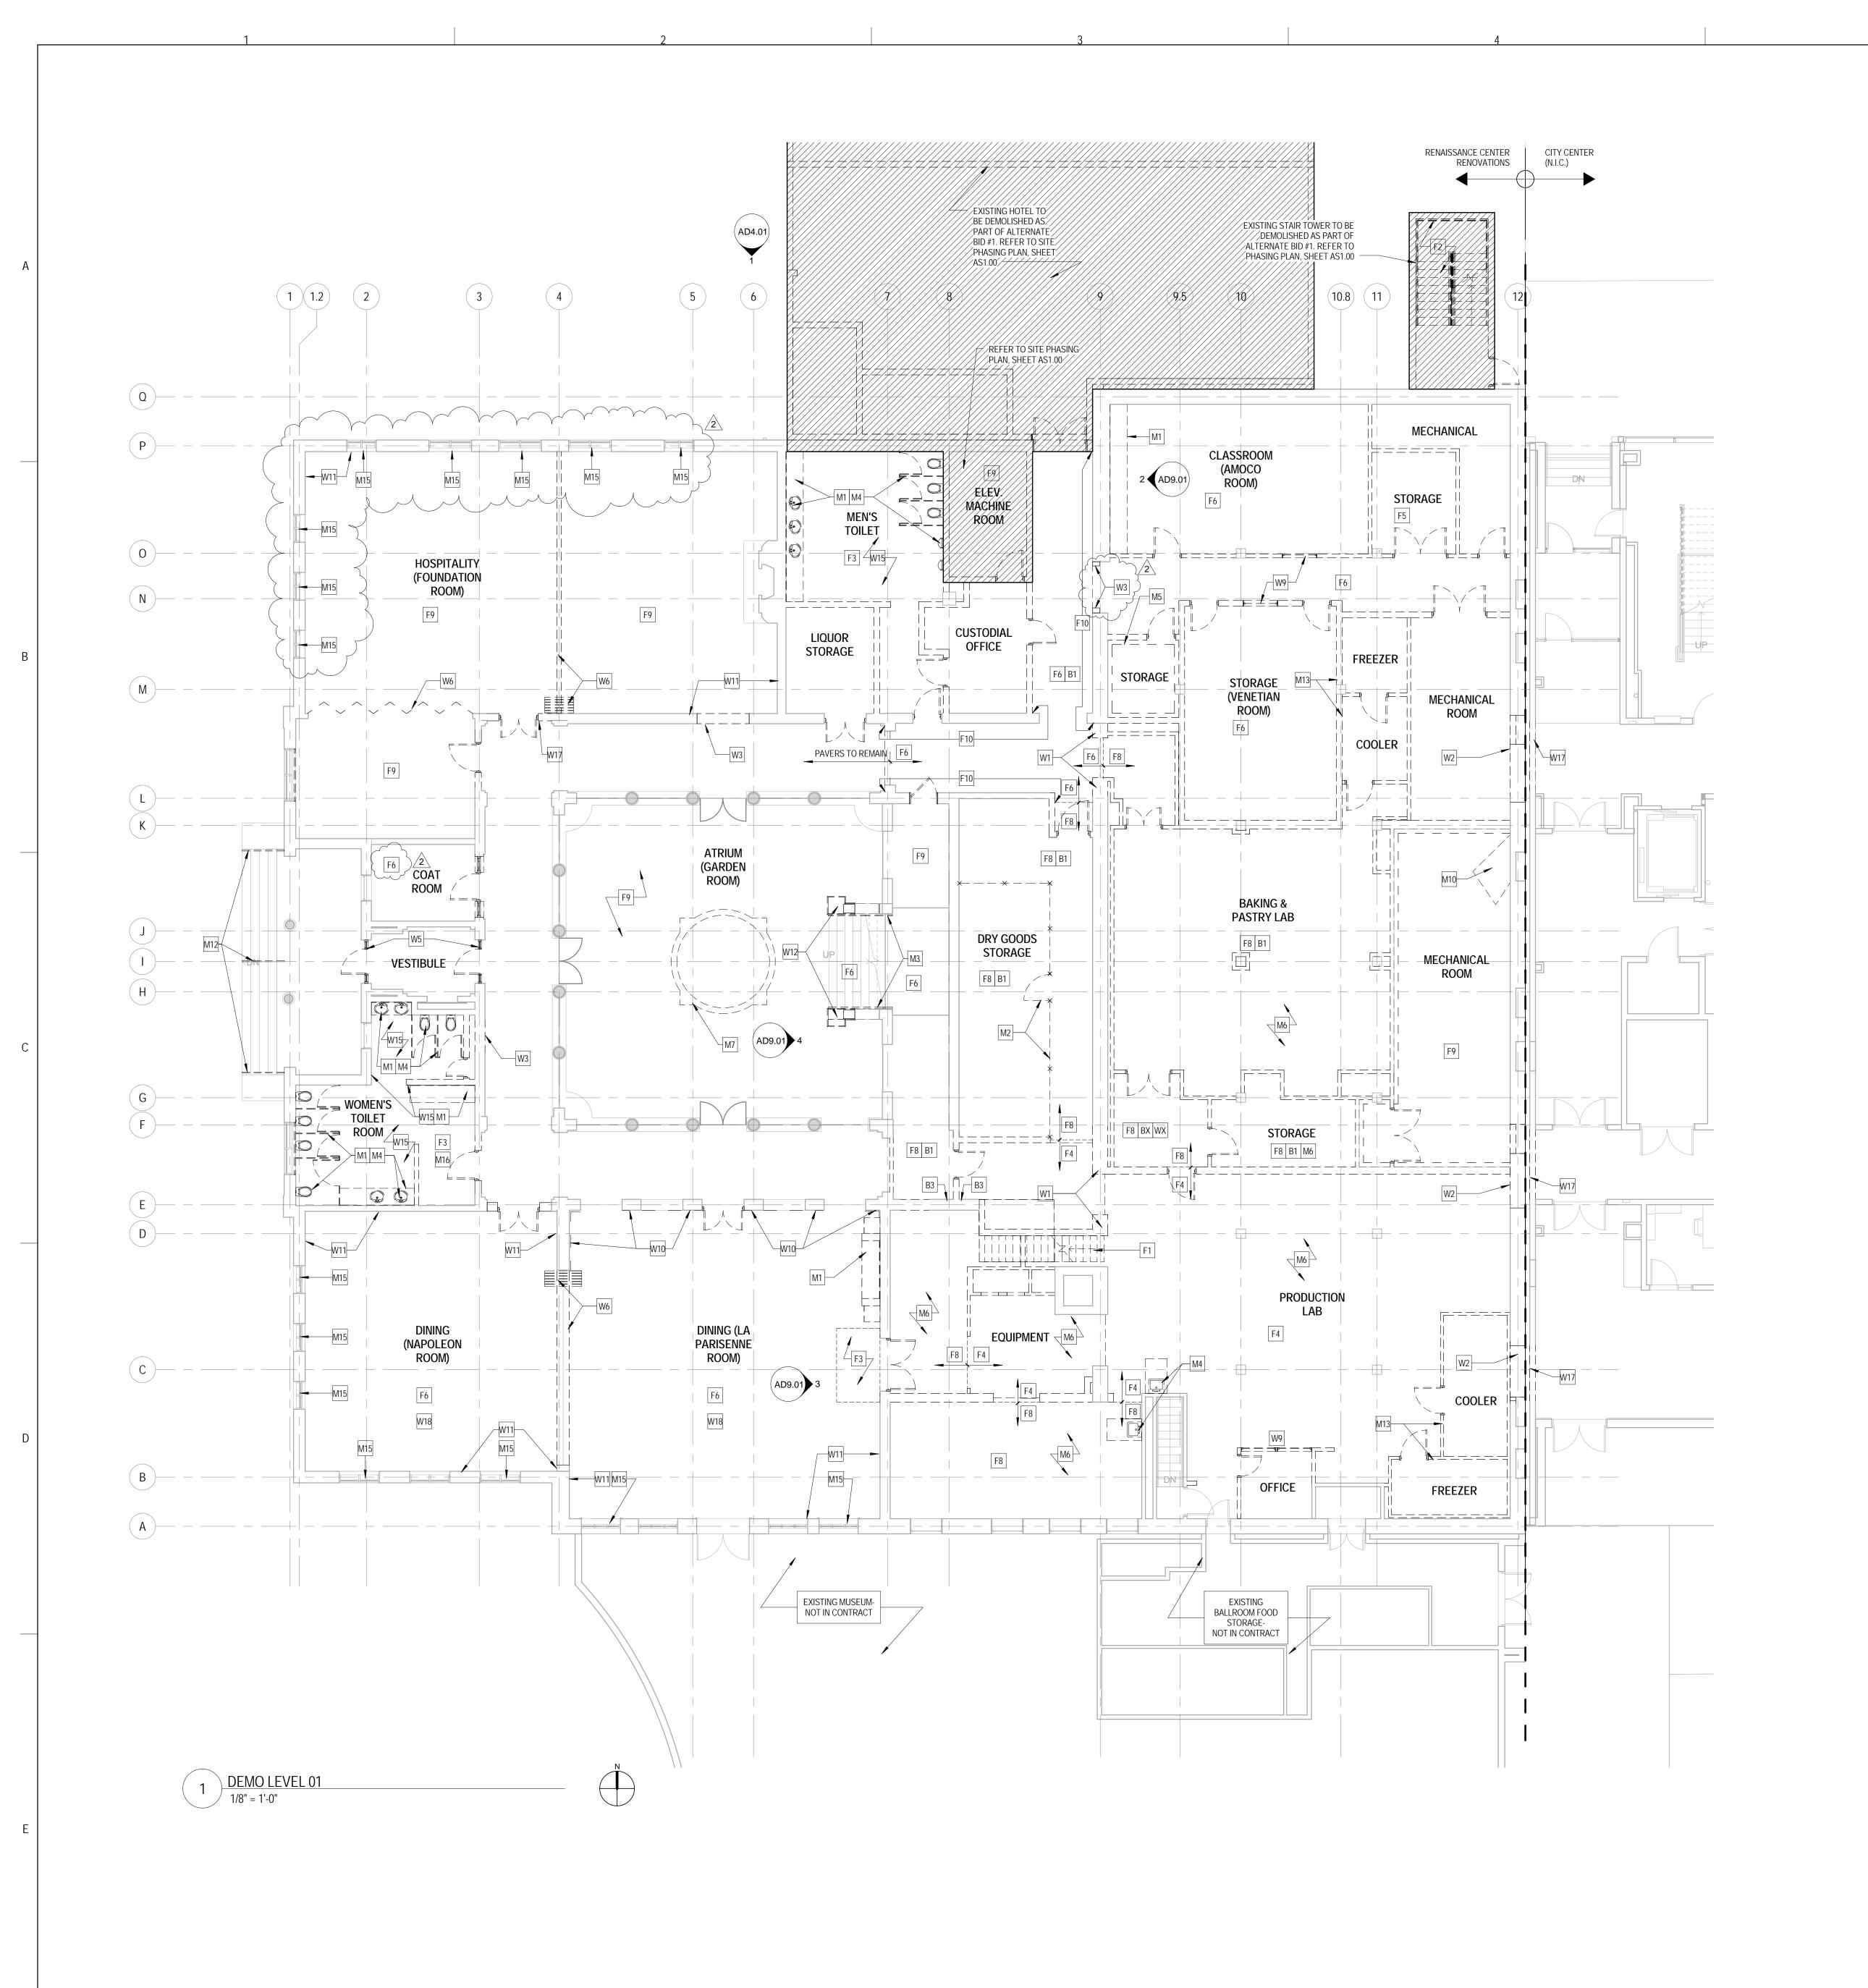

### DEMO FLOOR PLAN SYMBOLS LEGEND:

NOTE: REFER TO M.E.P.F.P. DRAWINGS FOR ADDITIONAL INFORMATION ON MECHANICAL, ELECTRICAL, AND FIRE PROTECTION SYSTEMS

GYPSUM BOARD OR PLASTER PARTITION TO BE REMOVED

CMU PARTITION TO BE REMOVED

FRAME AND DOOR TO BE REMOVED, SALVAGE HARDWARE TO OWNER

### **DEMO FLOOR PLAN GENERAL NOTES:**

- PRIOR TO AND DURING ANY DEMOLITION THE CONTRACTOR SHALL VERIFY AND MAINTAIN THE BUILDING'S STRUCTURAL INTEGRITY. CONTRACTOR SHALL BE RESPONSIBLE FOR ALL DEMOLITON AS REQUIRED TO
- INSTALL ALL NEW WORK. REPAIR, PATCH AND FINISH EXISTING FLOORS, WALLS AND CEILINGS DESIGNATED TO REMAIN TO MATCH EXISTING CONDITIONS. REMOVE ALL HANGERS, SUSPENSION SYSTEMS, SUPPORT FRAMING, EQUIPMENT

PADS, ANCHORS, ATTACHEMENT HARDWARE AND RELATED APPURTANCES

- CONNECTED WITH THE WORK TO BE DEMOLISHED. IF COMPLETE REMOVAL IS NOT POSSIBLE, CUT DEVICES AS CLOSE AS POSSIBLE TO ADJOINING SURFACES OR ORIGIN OF SUPPORT. DURING THE BIDDING PERIOD, EACH BIDDING CONTRACTOR SHALL VISIT THE SITE AND THE FACILITY TO DETERMINE EXISTING CONDITIONS. CONTRACTOR'S FAILURE TO REASONABLY DETERMINE AND/OR ANTICIPATE THE EFFECT OF EXISTING CONDITIONS
- COMPENSATION. NOTIFY ARCHITECT OF ANY DISCREPANCIES. ALL MATERIALS, EQUIPMENT, FIXTURES, SYSTEMS, AND ACCESSORIES WHICH ARE TO REMAIN IN SERVICE SHALL BE CLEANED, REPAIRED, ADJUSTED AND PLACED INTO

AND THE WORK INVOLVED THEREBY SHALL NOT BE JUSTIFICATION FOR ADDITIONAL

- PROPER OPERATIONS IN ALL MODES WITH THE ORIGINAL SYSTEM. WHEN TEMPORARY SHORING AND BRACING IS REQUIRED, CONTRACTOR SHALL RETAIN AND PAY FOR THE SERVICES OF A PROFESSIONAL ENGINEER-LICENSED TO PRACTICE IN THE STATE WHERE THE PROJECT IS LOCATED TO DESIGN AND PREPARE
- DETAILED DRAWINGS. CONTRACTOR SHALL COORDINATE SCHEDULE OF DEMOLITION WORK WITH THE OVERALL PHASING PLAN. ALL AREAS SURROUNDING EACH PHASE OF DEMOLITION/CONSTRUCTION WILL BE OCCUPIED BY THE OWNER DURING THE OWNER'S NORMAL BUSINESS HOURS. DEMOLITION WORK SHALL NOTE ENCUMBER THE USE OF EXISTING ADJACENT SPACES.

EACH CONTRACTOR SHALL FOLLOW THE PROGRESS OF THE GENERAL DEMOLITION AND REMODELING WORK TO ASSURE THE ACCESSIBILITY AND SAFETY OF EQUIPMENT

- AND SYSTEMS IN SERVICE IN ORDER TO PROVIDE FOR THE TIMELY REMOVAL AND/OR RELOCATION OF EQUIPMENT, PIPING, ETC. REMOVE ALL ABANDONED CONDUIT BOXES, CONDUCTORS, TELEPHONE LINES,
- ELECTRIC PANELS, AND ANY OTHER MISCELLANEOUS EQUIPMENT NOT REQUIRED FOR THE NEW FACILITY. REMOVE ALL RECESSED FLOOR BOXES, WALKER DUCTS, FLOORS SINKS, HUB DRAINS,
- ELECTRICAL RECEPTACLES, ETC. AND FILL VOIDS AS REQUIRED. REMOVE ALL DOOR STOPS AT ASSOCIATED DOORS TO BE DEMOLISHED. NO TOXIC SUBSTANCES HAVE BEEN NOTED ON THE SITE. SHOULD THE CONTRATOR ENCOUNTER ANY ASBESTOS, ASBESTOS PRODUCTS, PCBs OR OTHER TOXIC SUBSTANCES, THE CONTRACTOR SHOULD REPORT THIS IMMEDIATELY TO THE OWNER IN WRITING PRIOR TO CONTINUING WORK IN THIS AREA. WORK SHALL NOT BE RESUMED EXCEPT BY WRITTEN AUTHORIZATION OR AGREEMENT.
- ALL CONSTRUCTION DEBRIS AND EXCESS MATERIAL IS TO BE REMOVED BY THE CONTRACTOR AT THE END OF EACH WORK DAY. THE JOB SITE IS TO BE LEFT SUFFICIENTLY CLEAN AS TO WARRANT OWNER'S APPROVAL.
- REMOVE ALL CEILING SYSTEMS IN THEIR ENTIRETY, INCLUDING TILE, GRID, SUSPENSION WIRING, ANCHORS AND ALL ASSOCIATED APPURTENANCES.
- CONTRACTOR SHALL SALVAGE ALL EXISTING CEILING TILES FOR POSSIBLE REUSE OR AS EXTRA STOCK FOR OWNER. SALVAGE ONLY UN-CUT TILES WITH NO VISIBLE DAMAGE. ONCE REMOVED, OWNER AND ARCHITECT WILL FIELD REVIEW AND
- APPROVE SALVAGED TILES PRIOR TO REUSE OR STORAGE. REFER TO MECHANICAL, ELECTRICAL, FIRE PROTECTION, AND PLUMBING DEMOLITION DRAWINGS FOR ALL MEP/FP AND CUTTING, PATCHING, AND REPAIR OF ASSOCIATED ARCHITECTURAL COMPONENTS AND FINISHES.

### DEMO FLOOR PLAN REFERENCED NOTES: 1

### FLOOR DEMOLITION KEYED NOTES:

- 1: REMOVE STAIR AND ENCLOSING WALLS. DETERMINE STRUCTURE FOR FLOOR OPENING AND SHORE WHERE NECESSARY. REMOVE STAIR IN ITS ENTIRETY ALONG WITH EXTERIOR WALLS, ROOF, AND FOUNDATION FOR STAIR ENCLOSURE AS PART OF ALTERNATE BID #1 - REFER TO ADO.01 FOR MORE
- INFORMATION F3: DEMO ALL TILE FLOOR FINISH DOWN TO ORIGINAL SUBFLOORING. F4: DEMO TERRAZZO FLOOR DOWN TO ORIGINAL SUBFLOORING.
- F5: REMOVE RESILIENT FLOORING IN ITS ENTIRETY. F6: REMOVE CARPET FLOORING IN ITS ENTIRETY.
- F7: REMOVE HARDWOOD FLOOR IN ITS ENTIRETY. F8: REMOVE VCT IN ITS ENTIRETY.
- F9: EXISTING FLOORING IN THIS AREA WILL BE REMOVED BY REMDIATION CONTRACTOR PRIOR TO CONTRUCTION. REMOVAL OF FLOORING IS NOT IN CONTRACT.
- F10: REMOVE RUBBER BASE

### BASE DEMOLITION KEYED NOTES: B1: REMOVE RESILIENT WALL BASE.

B2: REMOVE TILE WALL BASE. B3: REMOVE PLASTER WALL BASE

### WALL DEMOLITION KEYED NOTES W1: REMOVE PORTION OF EXISTING MASONRY WALL FOR NEW OPENING. SHORE AND SUPPORT WALL STRUCTURE AND SECOND FLOOR STRUCTURE AS NECESSARY. N2: REMOVE PORTION OF EXISTING EXTERIOR MASONRY WALL FOR NEW OPENING. SHORE AND SUPPORT WALL STRUCTURE AND SECOND FLOOR STRUCTURE AS NECESSARY.

- W3: REMOVE PORTION OF EXISTING INTERIOR PARITION FOR NEW OPENING. W4: REMOVE COLUMN COVER MATERIAL AND STRUCTURE DOWN TO THE ORIGINAL PLASTER
- COLUMN FINISH. W5: REMOVE STOREFRONT SYSTEM IN ITS ENTIRETY. W6: REMOVE OPERABLE PARTITION WALL, TRACKS, AND HARDWARE.
- W7: REMOVE METAL LOCKERS. W8: REMOVE WOOD DOOR AND SIDELIGHTS, TRANSOMS AND SHUTTERS IN THEIR ENTIRETY
- W9: REMOVE INTERIOR WINDOW AND FRAME. W10: REMOVE BRICK WAINSCOTT AND SILL AT INSIDE OF WALL
- W11: REMOVE WALL COVERING, WAINSCOTTING, CHAIRRAIL AND WINDOW CASING AT ENTIRE WALL. EXISTING WALL CONSTRUCTION TO REMAIN. W12: REMOVE PORTH<del>on</del> of Existing Masonry Wall as Shown. Exact location to be
- PETERNIMED BASEDON LOCATION OF EXISTING VISIBLE PLASTERILINE.
- W13: REMOVE WALL OR PORTION OF WALL UNDER ALTERNATE BID #1. SHORE AND SUPPORT WALL STRUCTURE AND SECOND FLOOR STRUCTURE AS NECESSARY. WT4: REMOVE DOOR UNDER ALTERNATE BID #1 W15: REMOVE ALL EXISTING WALL TILE IN ROOM ON ANY EXISTING WALLS TO REMAIN IN ITS
- W16: REMOVE PLASTER FROM EXISTING WALL FACE. W17: REMOVE PORTION OF EXISTING THREE HOUR FIRE RATED GYP BD AND METAL STUD PARTITION IN THE ADJACENT CITY CENTER BUILDING FOR NEW DOOR(S). COORDINATE
- WORK WITH CITY CENTER CONTRACTOR. W18: REMOVE BOARD AND BATTEN. W19: REMOVE CROWN MOLDING. W20: REMOVE WALLCOVERING IN ITS ENTIRETY.

- **CEILING DEMOLITION KEYED NOTES:** C1: REMOVE SUSPENDED CEILING SYSTEM AND ALL LIGHTS AND DIFFUSERS IN THEIR
- C2: REMOVE PENDANT LIGHT FIXTURE C3: REMOVE EXISTING HARD CEILING IN ITS ENTIRETY.
- C4: REMOVE CEILING FAN.
- C5: EXISTING WOOD TRIM CEILING TO REMAIN. C6: EXISTING PLASTER CEILING TO REMAIN. C7: EXISTING WOOD TRIM AND PLASTER CEILING TO REMAIN.
- C8: REMOVE CORBEL. C9: REMOVE CROWN MOLDING AROUND PERIMETER OF ROOM.

### MISCELLANEOUS DEMOLITION KEYED NOTES

M8: REMOVE EXISTING SHUTTERS

- M1: REMOVE ALL MILLWORK AND/ OR CASEWORK IN ITS ENTIRETY. M2: REMOVE METAL FENCE, GATE, HARDWARE, AND STORAGE RACKS. M3: REMOVE HANDRAIL IN ITS ENTIRETY
- M4: REMOVE TOILET PARTITIONS AND PLUMBING FIXTURES IN THEIR ENTIRETY. M5: REMOVE WALK IN SAFE IN ITS ENTIRETY
- M6: REMOVE ALL EXISTING KITCHEN CASEWORK, COUNTERTOPS, AND EQUIPMENT WITHIN M7: REMOVE EXISTING FOUNTAIN, CONC. PLANTER, AND BASE IN ITS ENTIRETY
- M9: REMOVE BAR TOP AND BAR BASE CABINETS AND SINKS IN THEIR ENTIRETY. FRONT BAR PANELS TO BE RETAINED AND REFINISHED FOR REINSTALLATION.
- M10: REMOVE EXISTING RAMP. M11: REMOVE EXISTING SHUDDERS AT THIS OPENING AND REINSTALL IN NEW LOCATION IN
- BALLROOM REFER TO NEW WORK PLANS FOR LOCATIONS M12: REMOVE HANDRAILS IN THEIR ENTIRETY. PATCH AND REPAIR ANY HOLES IN EXISTING WALLS AND PAINT TO MATCH ADJACENT. PATCH ANY REMAINING HOLES NOT USED FOR
- NEW HANDRAILS IN STAIR AND SIDEWALK PAVING. M13: REMOVE EXISTING EQUIPMENT. M14: REMOVE AND RETAIN EXISTING SHUTTERS.
- M15: REMOVE WINDOW TREATMENTS
- M16: SALVAGE PAPER TOWEL DISPENSERS, TOILET PAPER DISPENSERS, MIRRORS AND GRAB
- M17: REMOVE WOOD SHUTTERS AND EXISTING WROUGHT IRON RAILING

ARCHITECT OF RECORD DEMONICA KEMPER ARCHITECTS 125 N. HALSTED STREET, SUITE 301 CHICAGO, IL 60661 P: 312.496.0000

STRUCTURAL & MEP/FP ENGINEERS KJWW ENGINEERING 1100 WARRENVILLE ROAD, #400W NAPERVILLE, IL 60563 T: 630.753.8553


FOOD SERVICE DESIGN CONSULTANTS **EF WHITNEY** 568 ANN ST.

BIRMINGHAM, MI 48009 T: 248.644.0990 CIVIL ENGINEERS

**RUETTIGER, TONELLI &** ASSOCIATES 129 CAPISTA DRIVE SHOREWOOD, IL 60404 T: 815.744.6600


KEY PLAN:

02/18/2016 SHEET STATUS: **ISSUED FOR BID** 

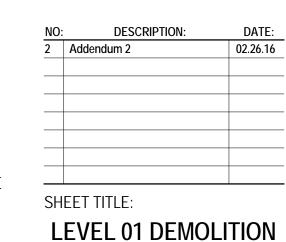

SHEET NUMBER:

2/25/2016 4:30:33 PM

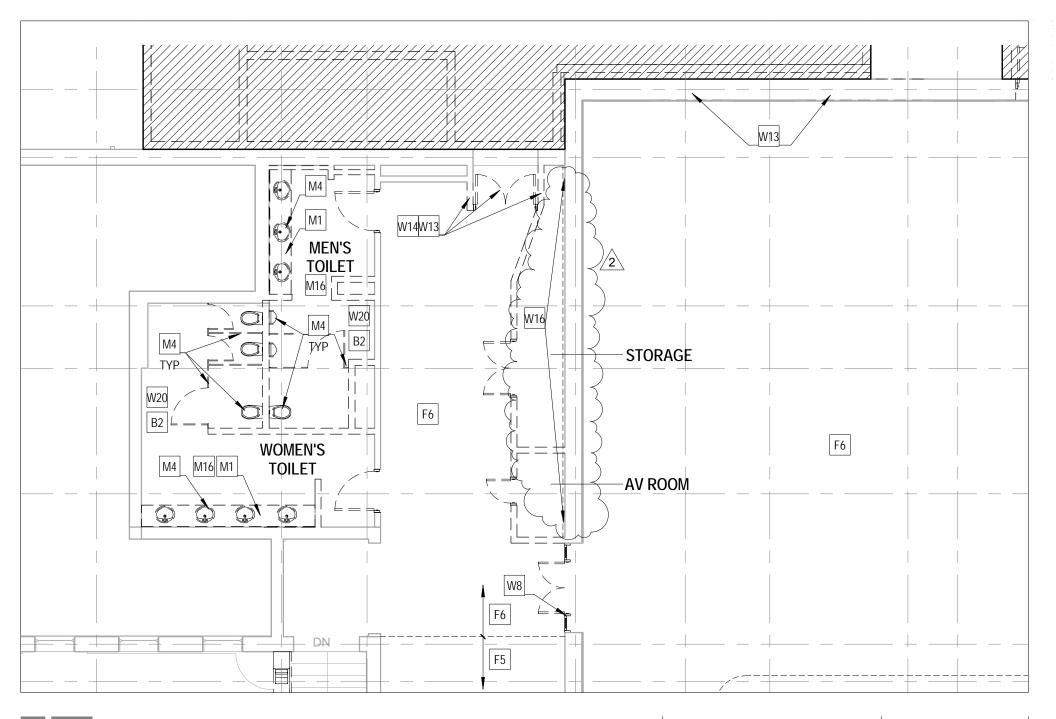




JOLIET JUNIOR COLLEGE RENAISSANCE CENTER RENOVATION PROJECT: 14-025

DATE: 02.26.16

REF SHEET: AD1.21

Addendum 2

AD121-01

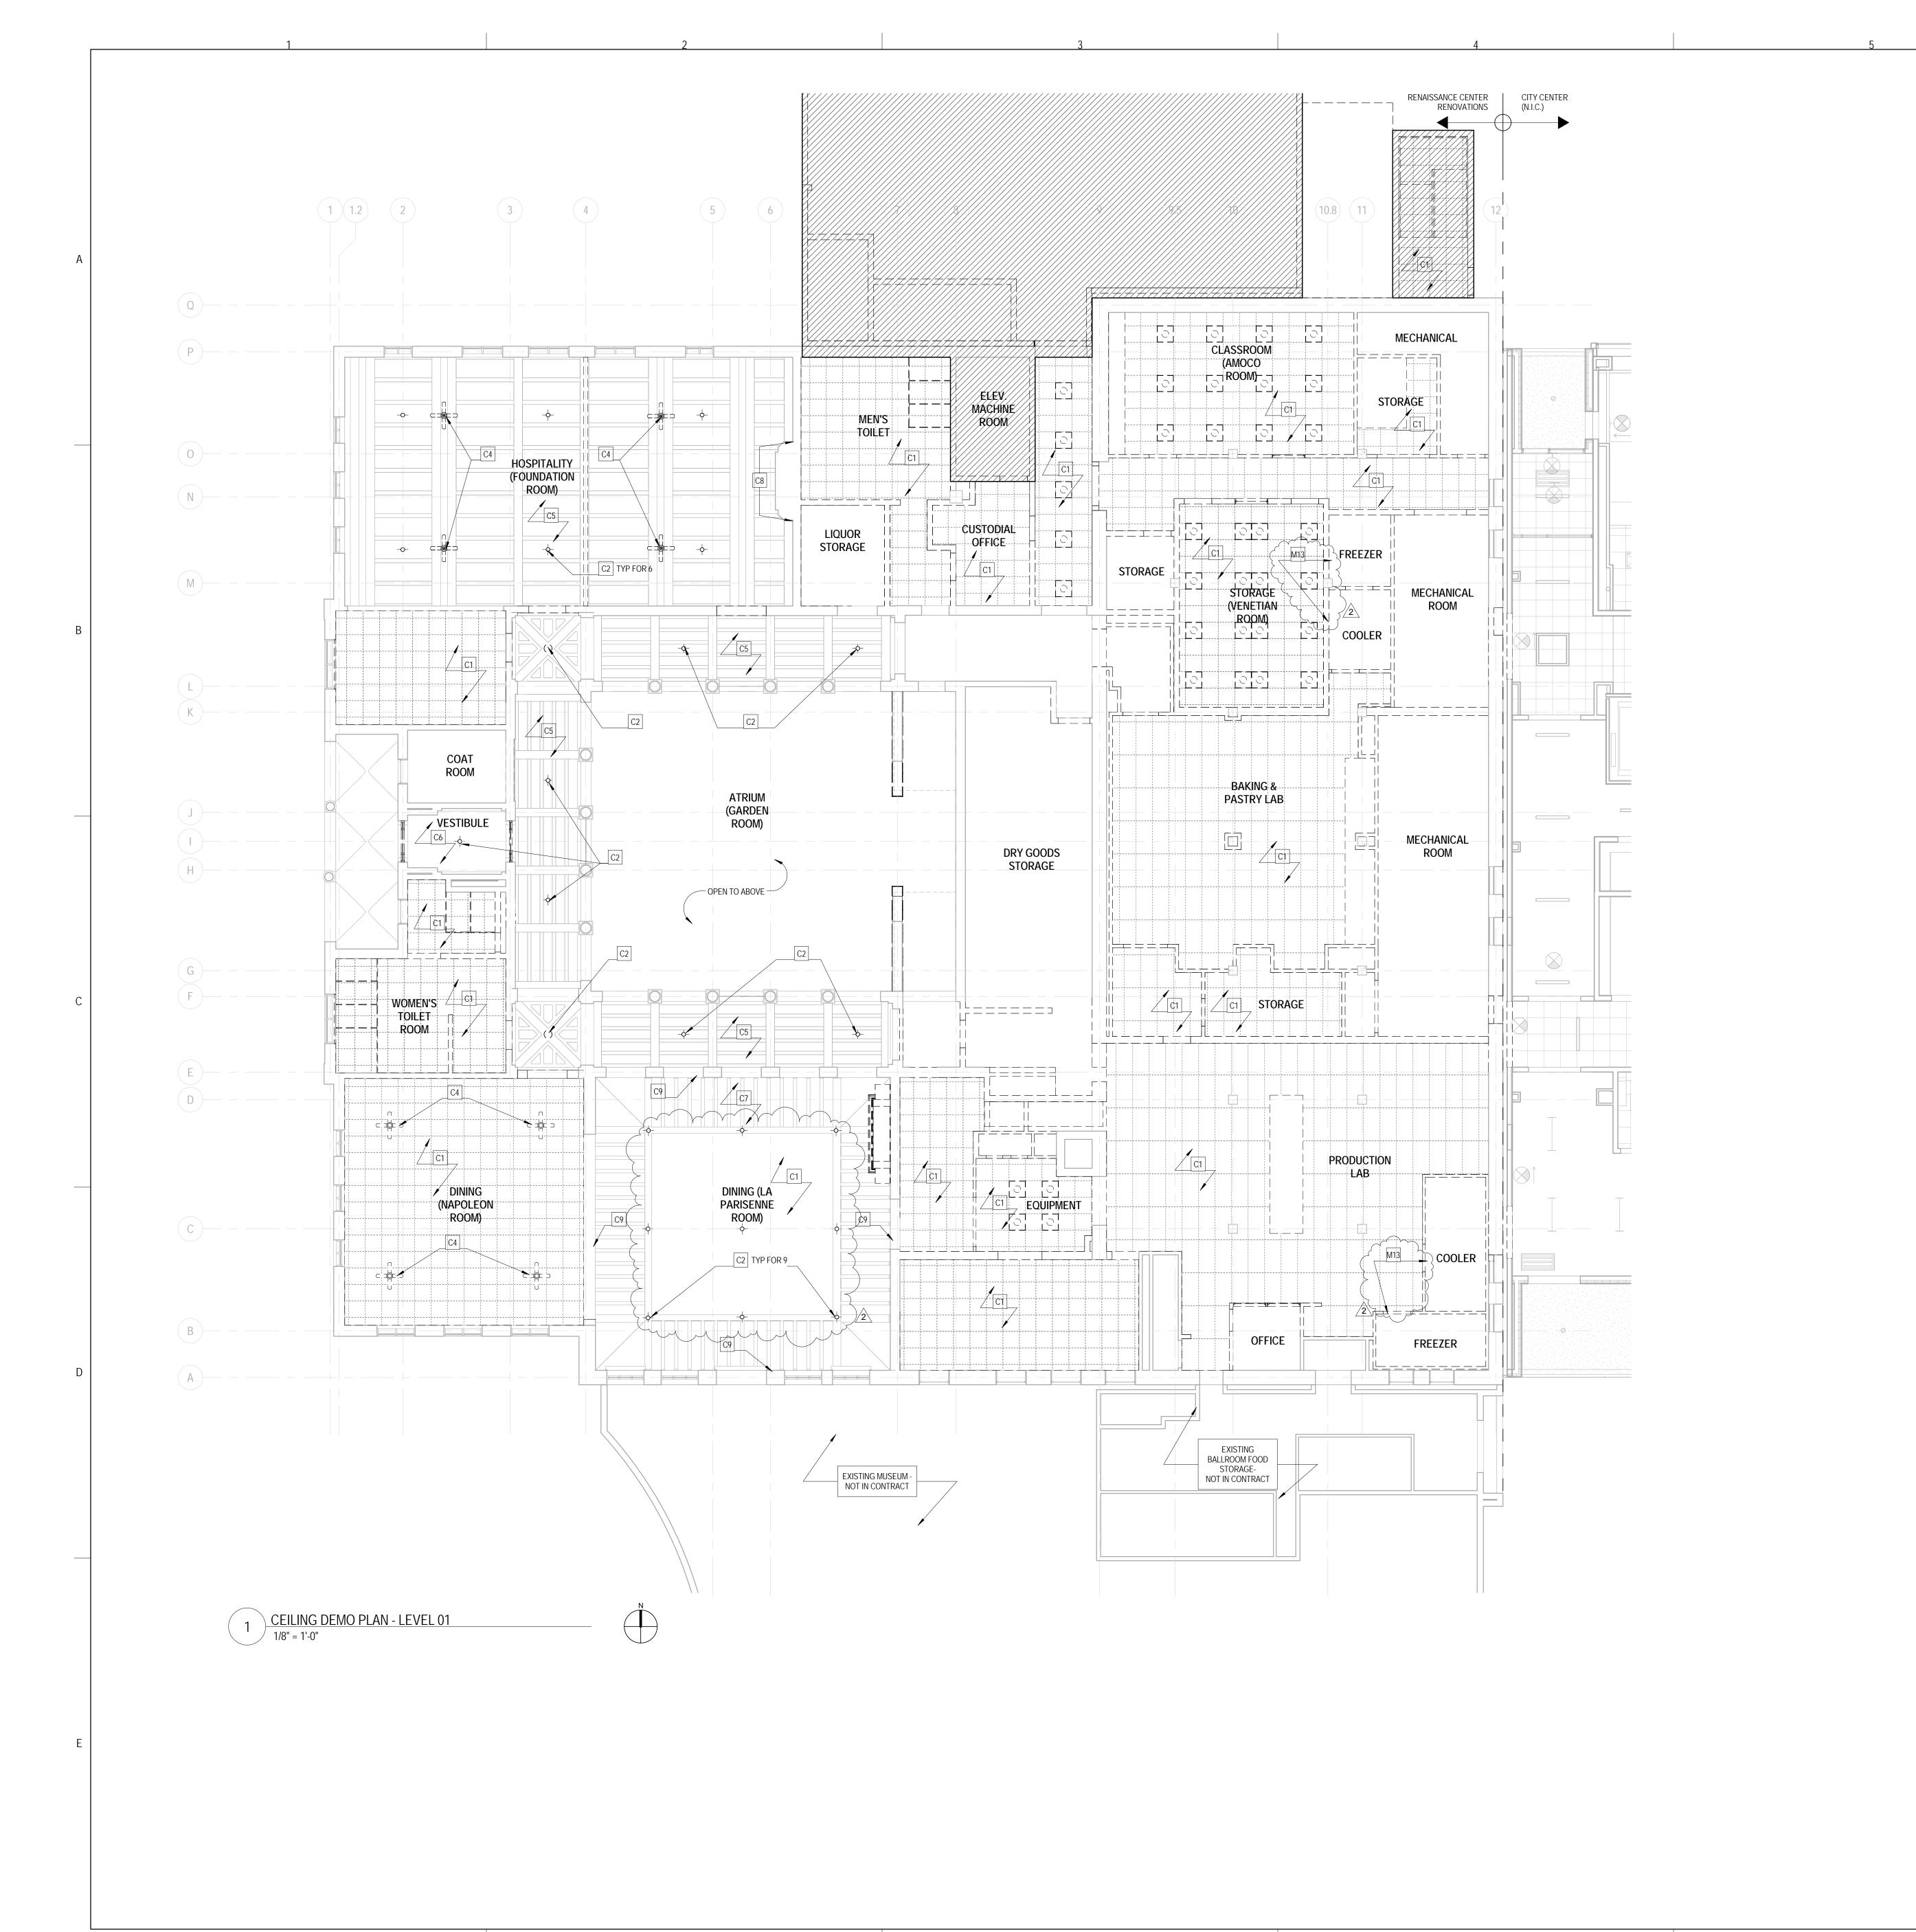

### DEMO FLOOR PLAN SYMBOLS LEGEND:

NOTE: REFER TO M.E.P.F.P. DRAWINGS FOR ADDITIONAL INFORMATION ON MECHANICAL, ELECTRICAL, AND FIRE PROTECTION SYSTEMS

> GYPSUM BOARD OR PLASTER PARTITION TO BE REMOVED CMU PARTITION TO BE REMOVED

> > FRAME AND DOOR TO BE REMOVED, SALVAGE HARDWARE TO OWNER

### DEMO FLOOR PLAN GENERAL NOTES:

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CEILINGS DESIGNATED TO REMAIN TO MATCH EXISTING CONDITIONS.

- REMOVE ALL HANGERS, SUSPENSION SYSTEMS, SUPPORT FRAMING, EQUIPMENT PADS, ANCHORS, ATTACHEMENT HARDWARE AND RELATED APPURTANCES CONNECTED WITH THE WORK TO BE DEMOLISHED. IF COMPLETE REMOVAL IS NOT POSSIBLE, CUT DEVICES AS CLOSE AS POSSIBLE TO ADJOINING SURFACES OR ORIGIN OF SUPPORT.
- DURING THE BIDDING PERIOD, EACH BIDDING CONTRACTOR SHALL VISIT THE SITE AND THE FACILITY TO DETERMINE EXISTING CONDITIONS. CONTRACTOR'S FAILURE TO REASONABLY DETERMINE AND/OR ANTICIPATE THE EFFECT OF EXISTING CONDITIONS AND THE WORK INVOLVED THEREBY SHALL NOT BE JUSTIFICATION FOR ADDITIONAL COMPENSATION. NOTIFY ARCHITECT OF ANY DISCREPANCIES. ALL MATERIALS, EQUIPMENT, FIXTURES, SYSTEMS, AND ACCESSORIES WHICH ARE TO
- PROPER OPERATIONS IN ALL MODES WITH THE ORIGINAL SYSTEM. WHEN TEMPORARY SHORING AND BRACING IS REQUIRED, CONTRACTOR SHALL RETAIN AND PAY FOR THE SERVICES OF A PROFESSIONAL ENGINEER-LICENSED TO PRACTICE IN THE STATE WHERE THE PROJECT IS LOCATED TO DESIGN AND PREPARE

REMAIN IN SERVICE SHALL BE CLEANED, REPAIRED, ADJUSTED AND PLACED INTO

- DETAILED DRAWINGS. CONTRACTOR SHALL COORDINATE SCHEDULE OF DEMOLITION WORK WITH THE OVERALL PHASING PLAN. ALL AREAS SURROUNDING EACH PHASE OF DEMOLITION/CONSTRUCTION WILL BE OCCUPIED BY THE OWNER DURING THE OWNER'S NORMAL BUSINESS HOURS. DEMOLITION WORK SHALL NOTE ENCUMBER
- AND REMODELING WORK TO ASSURE THE ACCESSIBILITY AND SAFETY OF EQUIPMENT AND SYSTEMS IN SERVICE IN ORDER TO PROVIDE FOR THE TIMELY REMOVAL AND/OR RELOCATION OF EQUIPMENT, PIPING, ETC.

EACH CONTRACTOR SHALL FOLLOW THE PROGRESS OF THE GENERAL DEMOLITION

REMOVE ALL ABANDONED CONDUIT BOXES, CONDUCTORS, TELEPHONE LINES, ELECTRIC PANELS, AND ANY OTHER MISCELLANEOUS EQUIPMENT NOT REQUIRED FOR THE NEW FACILITY. REMOVE ALL RECESSED FLOOR BOXES, WALKER DUCTS, FLOORS SINKS, HUB DRAINS,

THE USE OF EXISTING ADJACENT SPACES.

- ELECTRICAL RECEPTACLES, ETC. AND FILL VOIDS AS REQUIRED. REMOVE ALL DOOR STOPS AT ASSOCIATED DOORS TO BE DEMOLISHED. NO TOXIC SUBSTANCES HAVE BEEN NOTED ON THE SITE. SHOULD THE CONTRATOR ENCOUNTER ANY ASBESTOS, ASBESTOS PRODUCTS, PCBs OR OTHER TOXIC SUBSTANCES, THE CONTRACTOR SHOULD REPORT THIS IMMEDIATELY TO THE
- RESUMED EXCEPT BY WRITTEN AUTHORIZATION OR AGREEMENT. ALL CONSTRUCTION DEBRIS AND EXCESS MATERIAL IS TO BE REMOVED BY THE CONTRACTOR AT THE END OF EACH WORK DAY. THE JOB SITE IS TO BE LEFT

OWNER IN WRITING PRIOR TO CONTINUING WORK IN THIS AREA. WORK SHALL NOT BE

- SUFFICIENTLY CLEAN AS TO WARRANT OWNER'S APPROVAL. REMOVE ALL CEILING SYSTEMS IN THEIR ENTIRETY, INCLUDING TILE, GRID, SUSPENSION WIRING, ANCHORS AND ALL ASSOCIATED APPURTENANCES.
- CONTRACTOR SHALL SALVAGE ALL EXISTING CEILING TILES FOR POSSIBLE REUSE OR AS EXTRA STOCK FOR OWNER. SALVAGE ONLY UN-CUT TILES WITH NO VISIBLE DAMAGE. ONCE REMOVED, OWNER AND ARCHITECT WILL FIELD REVIEW AND APPROVE SALVAGED TILES PRIOR TO REUSE OR STORAGE.
- REFER TO MECHANICAL, ELECTRICAL, FIRE PROTECTION, AND PLUMBING DEMOLITION ARCHITECTURAL COMPONENTS AND FINISHES.

### DEMO FLOOR PLAN REFERENCED NOTES: 1

LOOR DEMOLITION KEYED NOTES:

: REMOVE STAIR AND ENCLOSING WALLS. DETERMINE STRUCTURE FOR FLOOR OPENING AND SHORE WHERE NECESSARY. REMOVE STAIR IN ITS ENTIRETY ALONG WITH EXTERIOR WALLS, ROOF, AND FOUNDATION

- FOR STAIR ENCLOSURE AS PART OF ALTERNATE BID #1 REFER TO AD0.01 FOR MORE F3: DEMO ALL TILE FLOOR FINISH DOWN TO ORIGINAL SUBFLOORING.
- F4: DEMO TERRAZZO FLOOR DOWN TO ORIGINAL SUBFLOORING. F5: REMOVE RESILIENT FLOORING IN ITS ENTIRETY.
- F6: REMOVE CARPET FLOORING IN ITS ENTIRETY.
- F7: REMOVE HARDWOOD FLOOR IN ITS ENTIRETY. F8: REMOVE VCT IN ITS ENTIRETY.
- F9: EXISTING FLOORING IN THIS AREA WILL BE REMOVED BY REMDIATION CONTRACTOR PRIOR TO CONTRUCTION. REMOVAL OF FLOORING IS NOT IN CONTRACT.
- F10: REMOVE RUBBER BASE
- BASE DEMOLITION KEYED NOTES:
  B1: REMOVE RESILIENT WALL BASE. B2: REMOVE TILE WALL BASE. B3: REMOVE PLASTER WALL BASE

### WALL DEMOLITION KEYED NOTES

- W1: REMOVE PORTION OF EXISTING MASONRY WALL FOR NEW OPENING. SHORE AND SUPPORT WALL STRUCTURE AND SECOND FLOOR STRUCTURE AS NECESSARY.
- 2: REMOVE PORTION OF EXISTING EXTERIOR MASONRY WALL FOR NEW OPENING. SHORE AND SUPPORT WALL STRUCTURE AND SECOND FLOOR STRUCTURE AS NECESSARY.
- W3: REMOVE PORTION OF EXISTING INTERIOR PARITION FOR NEW OPENING. W4: REMOVE COLUMN COVER MATERIAL AND STRUCTURE DOWN TO THE ORIGINAL PLASTER COLUMN FINISH.
- W5: REMOVE STOREFRONT SYSTEM IN ITS ENTIRETY. W6: REMOVE OPERABLE PARTITION WALL, TRACKS, AND HARDWARE.
- W7: REMOVE METAL LOCKERS.
- W8: REMOVE WOOD DOOR AND SIDELIGHTS, TRANSOMS AND SHUTTERS IN THEIR ENTIRETY W9: REMOVE INTERIOR WINDOW AND FRAME.
- W10: REMOVE BRICK WAINSCOTT AND SILL AT INSIDE OF WALL W11: REMOVE WALL COVERING, WAINSCOTTING, CHAIRRAIL AND WINDOW CASING AT ENTIRE
- WALL. EXISTING WALL CONSTRUCTION TO REMAIN. W12: REMOVE PORTION OF EXISTING MASONRY WALL AS SHOWN. EXACT LOCATION TO BE ODETERNÝNEĎ BASED OŇ LOCATYON OF EXISTING VISIBLE PLASTER LINE.
- W13: REMOVE WALL OR PORTION OF WALL UNDER ALTERNATE BID #1. SHORE AND SUPPORT WALL □ STRUCTURE AND SECOND FLOOR STRUCTURE AS NECESSARY. W14: REMOVE DOOR UNDER ALTERNATE BID #1.
- W15: REMOVE ALL EXISTING WALL TILE IN ROOM ON ANY EXISTING WALLS TO REMAIN IN ITS
- W16: REMOVE PLASTER FROM EXISTING WALL FACE. W17: REMOVE PORTION OF EXISTING THREE HOUR FIRE RATED GYP BD AND METAL STUD
- PARTITION IN THE ADJACENT CITY CENTER BUILDING FOR NEW DOOR(S). COORDINATE WORK WITH CITY CENTER CONTRACTOR.
- W18: REMOVE BOARD AND BATTEN. W19: REMOVE CROWN MOLDING.
- W20: REMOVE WALLCOVERING IN ITS ENTIRETY

### C1: REMOVE SUSPENDED CEILING SYSTEM AND ALL LIGHTS AND DIFFUSERS IN THEIR

- C2: REMOVE PENDANT LIGHT FIXTURE
- C3: REMOVE EXISTING HARD CEILING IN ITS ENTIRETY. C4: REMOVE CEILING FAN.
- C5: EXISTING WOOD TRIM CEILING TO REMAIN. C6: EXISTING PLASTER CEILING TO REMAIN.
- C7: EXISTING WOOD TRIM AND PLASTER CEILING TO REMAIN. C8: REMOVE CORBEL.

### C9: REMOVE CROWN MOLDING AROUND PERIMETER OF ROOM.

MISCELLANEOUS DEMOLITION KEYED NOTES:

M5: REMOVE WALK IN SAFE IN ITS ENTIRETY

- M1: REMOVE ALL MILLWORK AND/ OR CASEWORK IN ITS ENTIRETY. M2: REMOVE METAL FENCE, GATE, HARDWARE, AND STORAGE RACKS.
- M3: REMOVE HANDRAIL IN ITS ENTIRETY M4: REMOVE TOILET PARTITIONS AND PLUMBING FIXTURES IN THEIR ENTIRETY
- M6: REMOVE ALL EXISTING KITCHEN CASEWORK, COUNTERTOPS, AND EQUIPMENT WITHIN
- M7: REMOVE EXISTING FOUNTAIN, CONC. PLANTER, AND BASE IN ITS ENTIRETY M8: REMOVE EXISTING SHUTTERS
- M9: REMOVE BAR TOP AND BAR BASE CABINETS AND SINKS IN THEIR ENTIRETY. FRONT BAR PANELS TO BE RETAINED AND REFINISHED FOR REINSTALLATION.
- M10: REMOVE EXISTING RAMP. M11: REMOVE EXISTING SHUDDERS AT THIS OPENING AND REINSTALL IN NEW LOCATION IN BALLROOM - REFER TO NEW WORK PLANS FOR LOCATIONS M12: REMOVE HANDRAILS IN THEIR ENTIRETY. PATCH AND REPAIR ANY HOLES IN EXISTING WALLS AND PAINT TO MATCH ADJACENT. PATCH ANY REMAINING HOLES NOT USED FOR
- NEW HANDRAILS IN STAIR AND SIDEWALK PAVING. M13: REMOVE EXISTING FOUIPMENT.
- M14: REMOVE AND RETAIN EXISTING SHUTTERS. M15: REMOVE WINDOW TREATMENTS
- M16: SALVAGE PAPER TOWEL DISPENSERS, TOILET PAPER DISPENSERS, MIRRORS AND GRAB M17: REMOVE WOOD SHUTTERS AND EXISTING WROUGHT IRON RAILING.

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T: 248.644.0990 CIVIL ENGINEERS **RUETTIGER, TONELLI &** ASSOCIATES 129 CAPISTA DRIVE SHOREWOOD, IL 60404

BIRMINGHAM, MI 48009

T: 815.744.6600

KEY PLAN:

02/18/2016 SHEET STATUS: **ISSUED FOR BID** 


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LEVEL 01

**CELING DEMO PLAN -**

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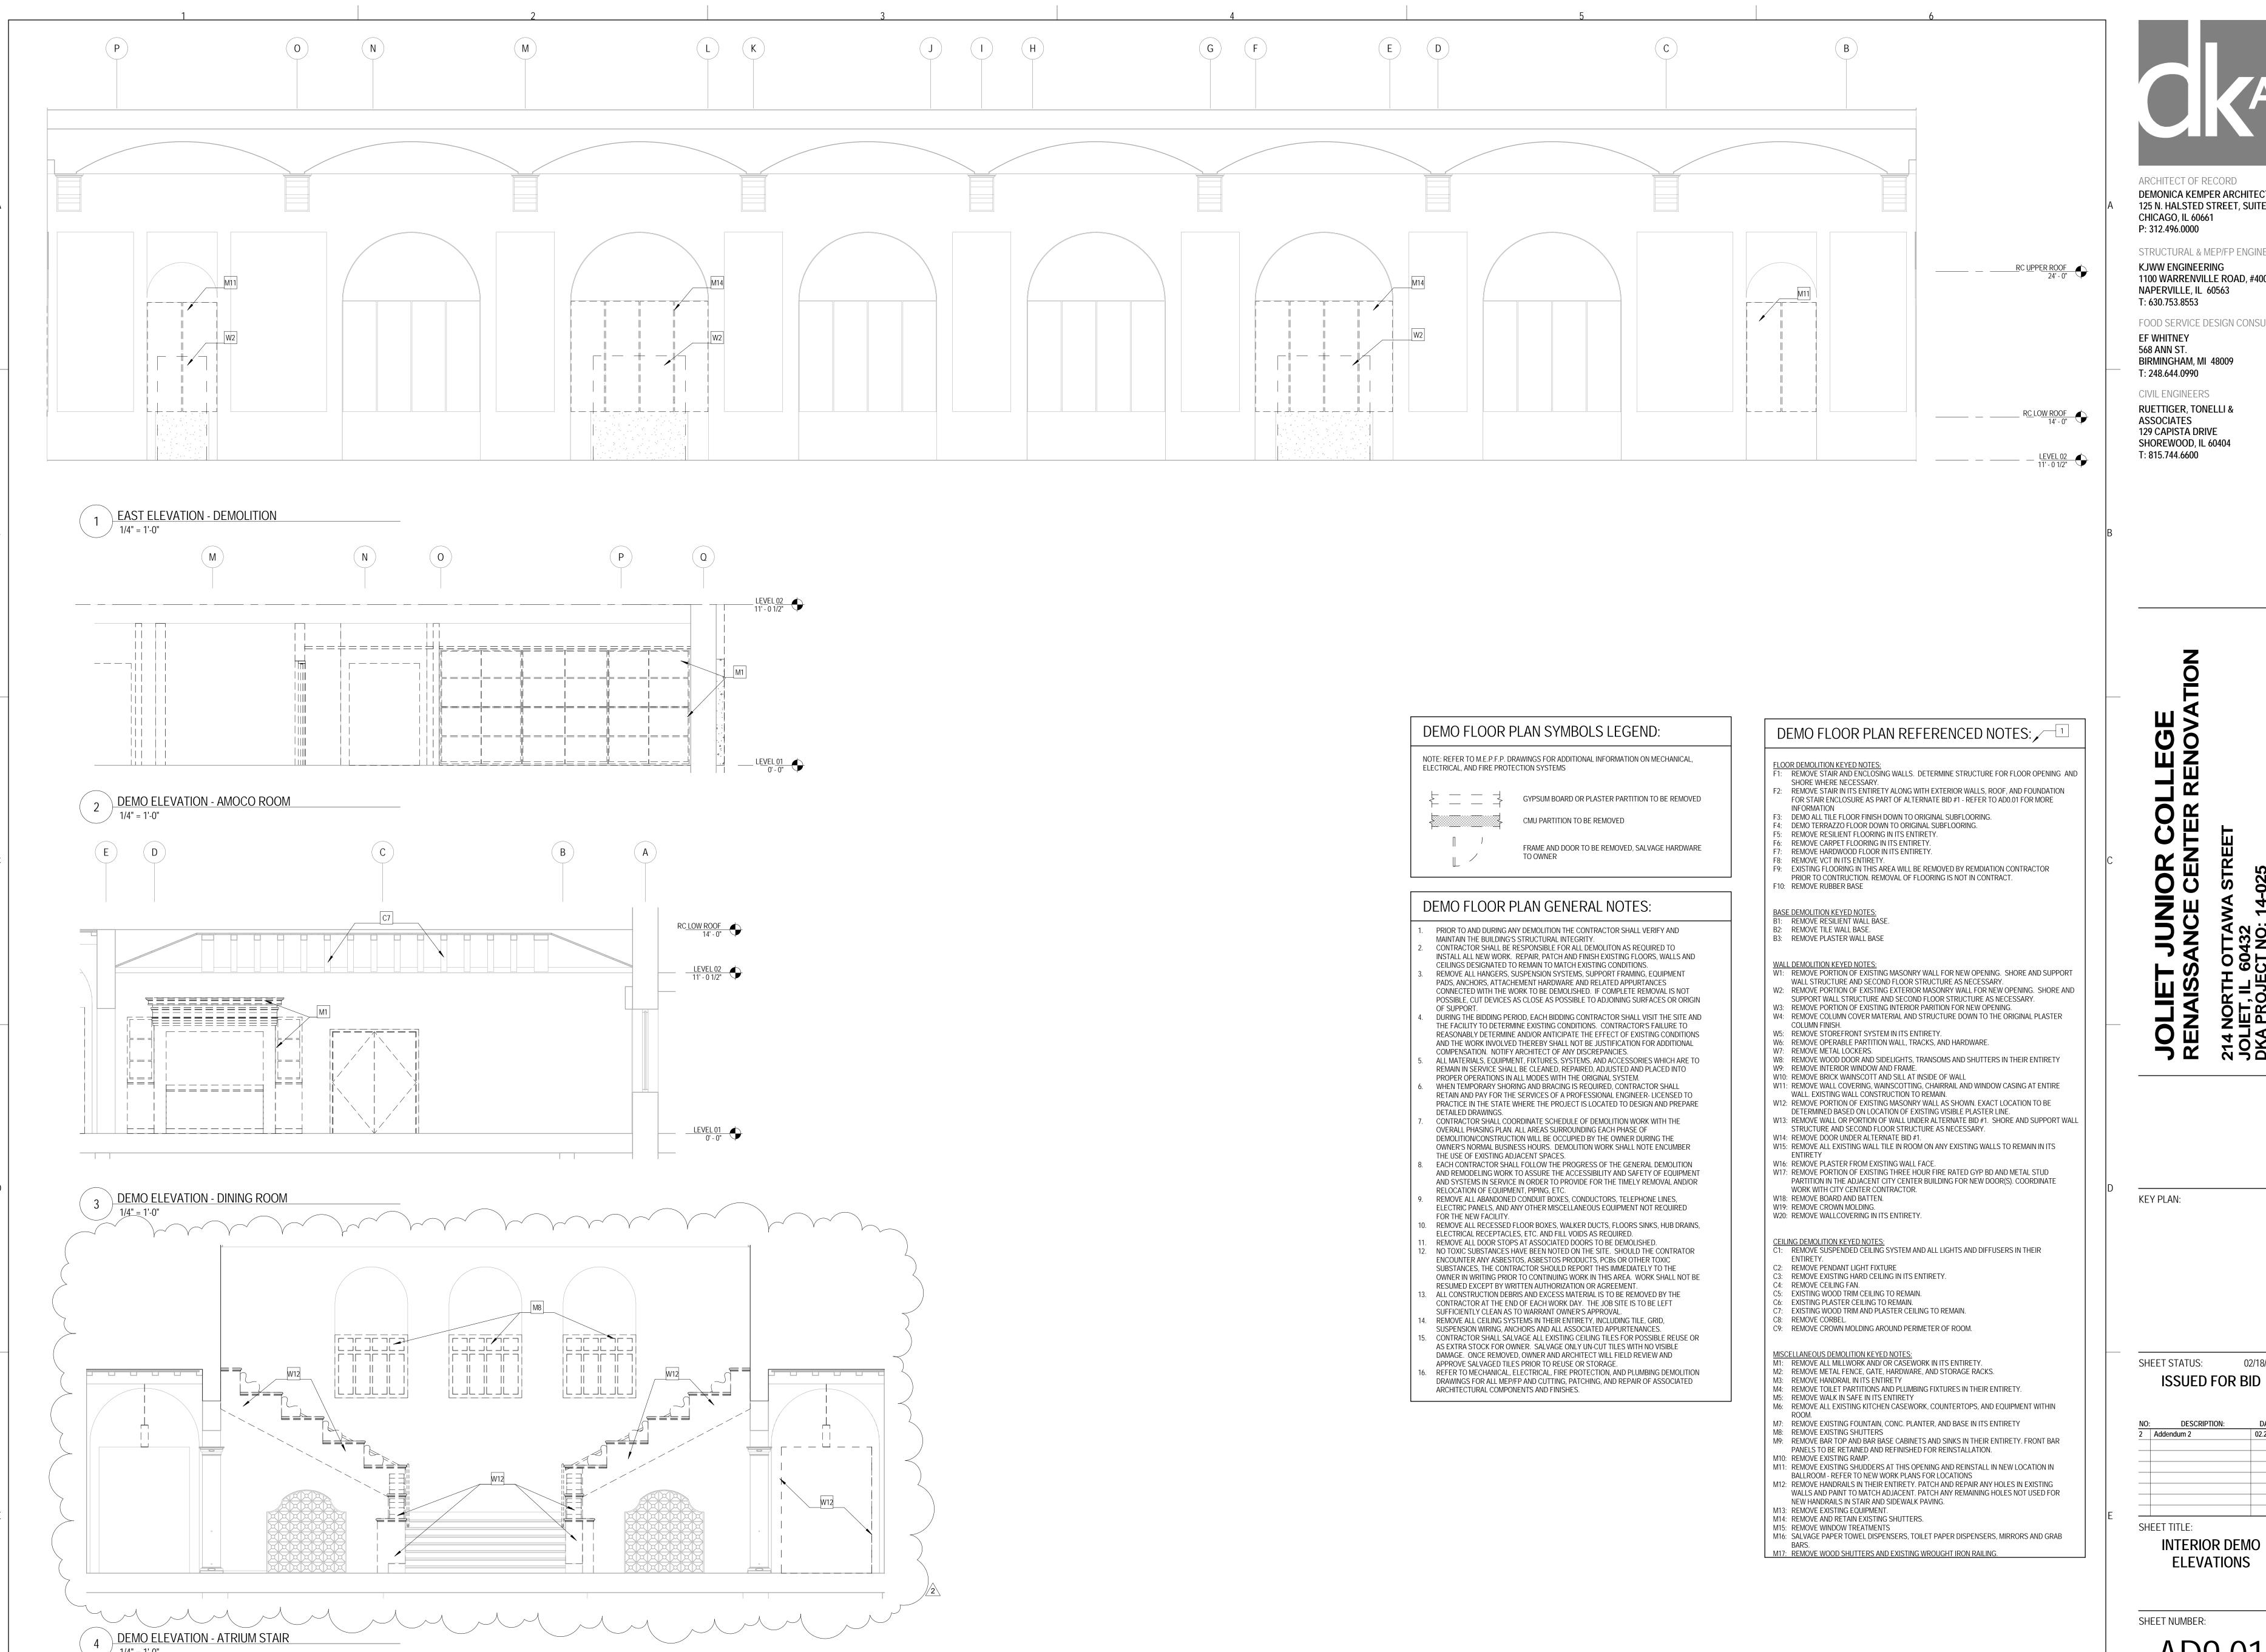
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DATE: 02.26.16

REF SHEET: AD2.21

Addendum 2

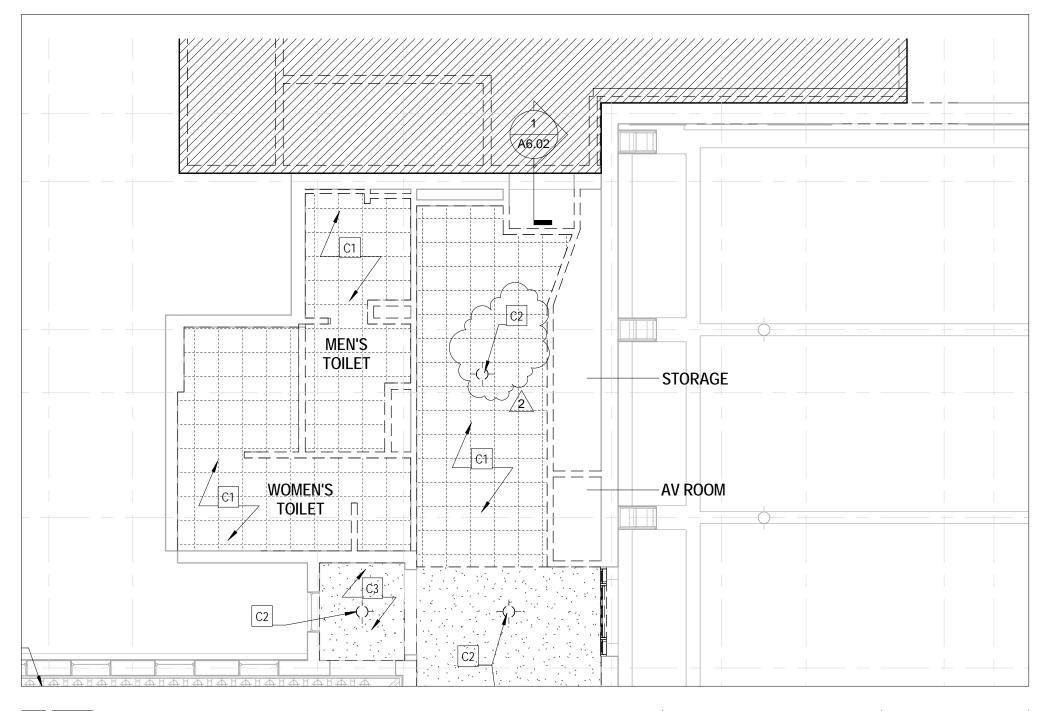AD221-01



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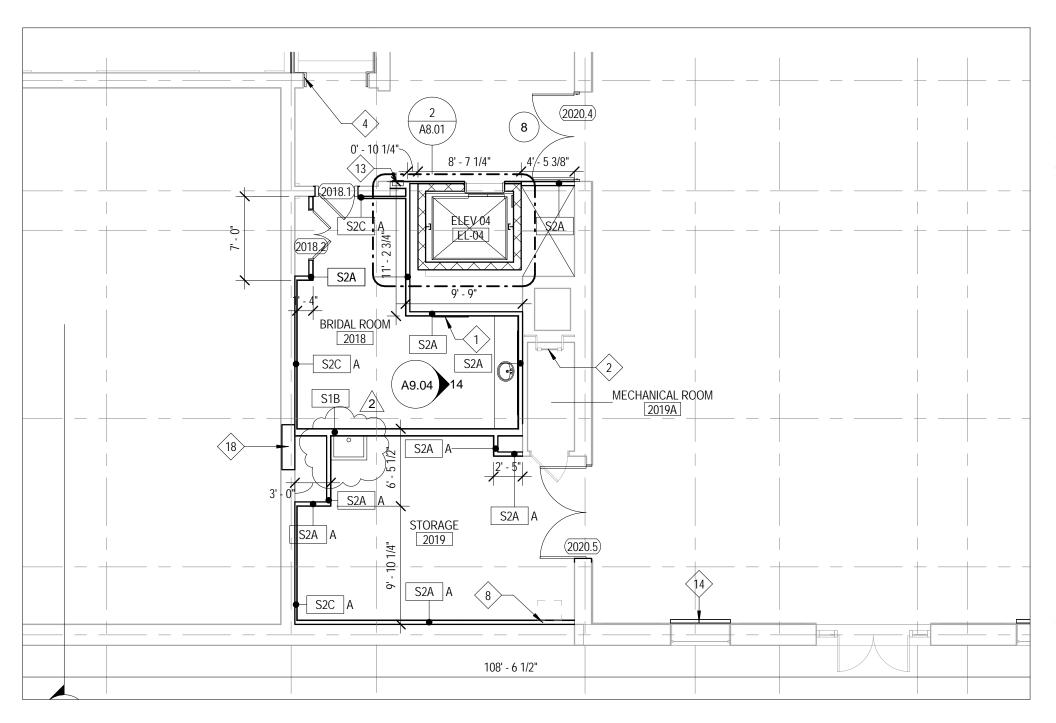
CIVIL ENGINEERS **RUETTIGER, TONELLI &** ASSOCIATES 129 CAPISTA DRIVE SHOREWOOD, IL 60404

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02/18/2016

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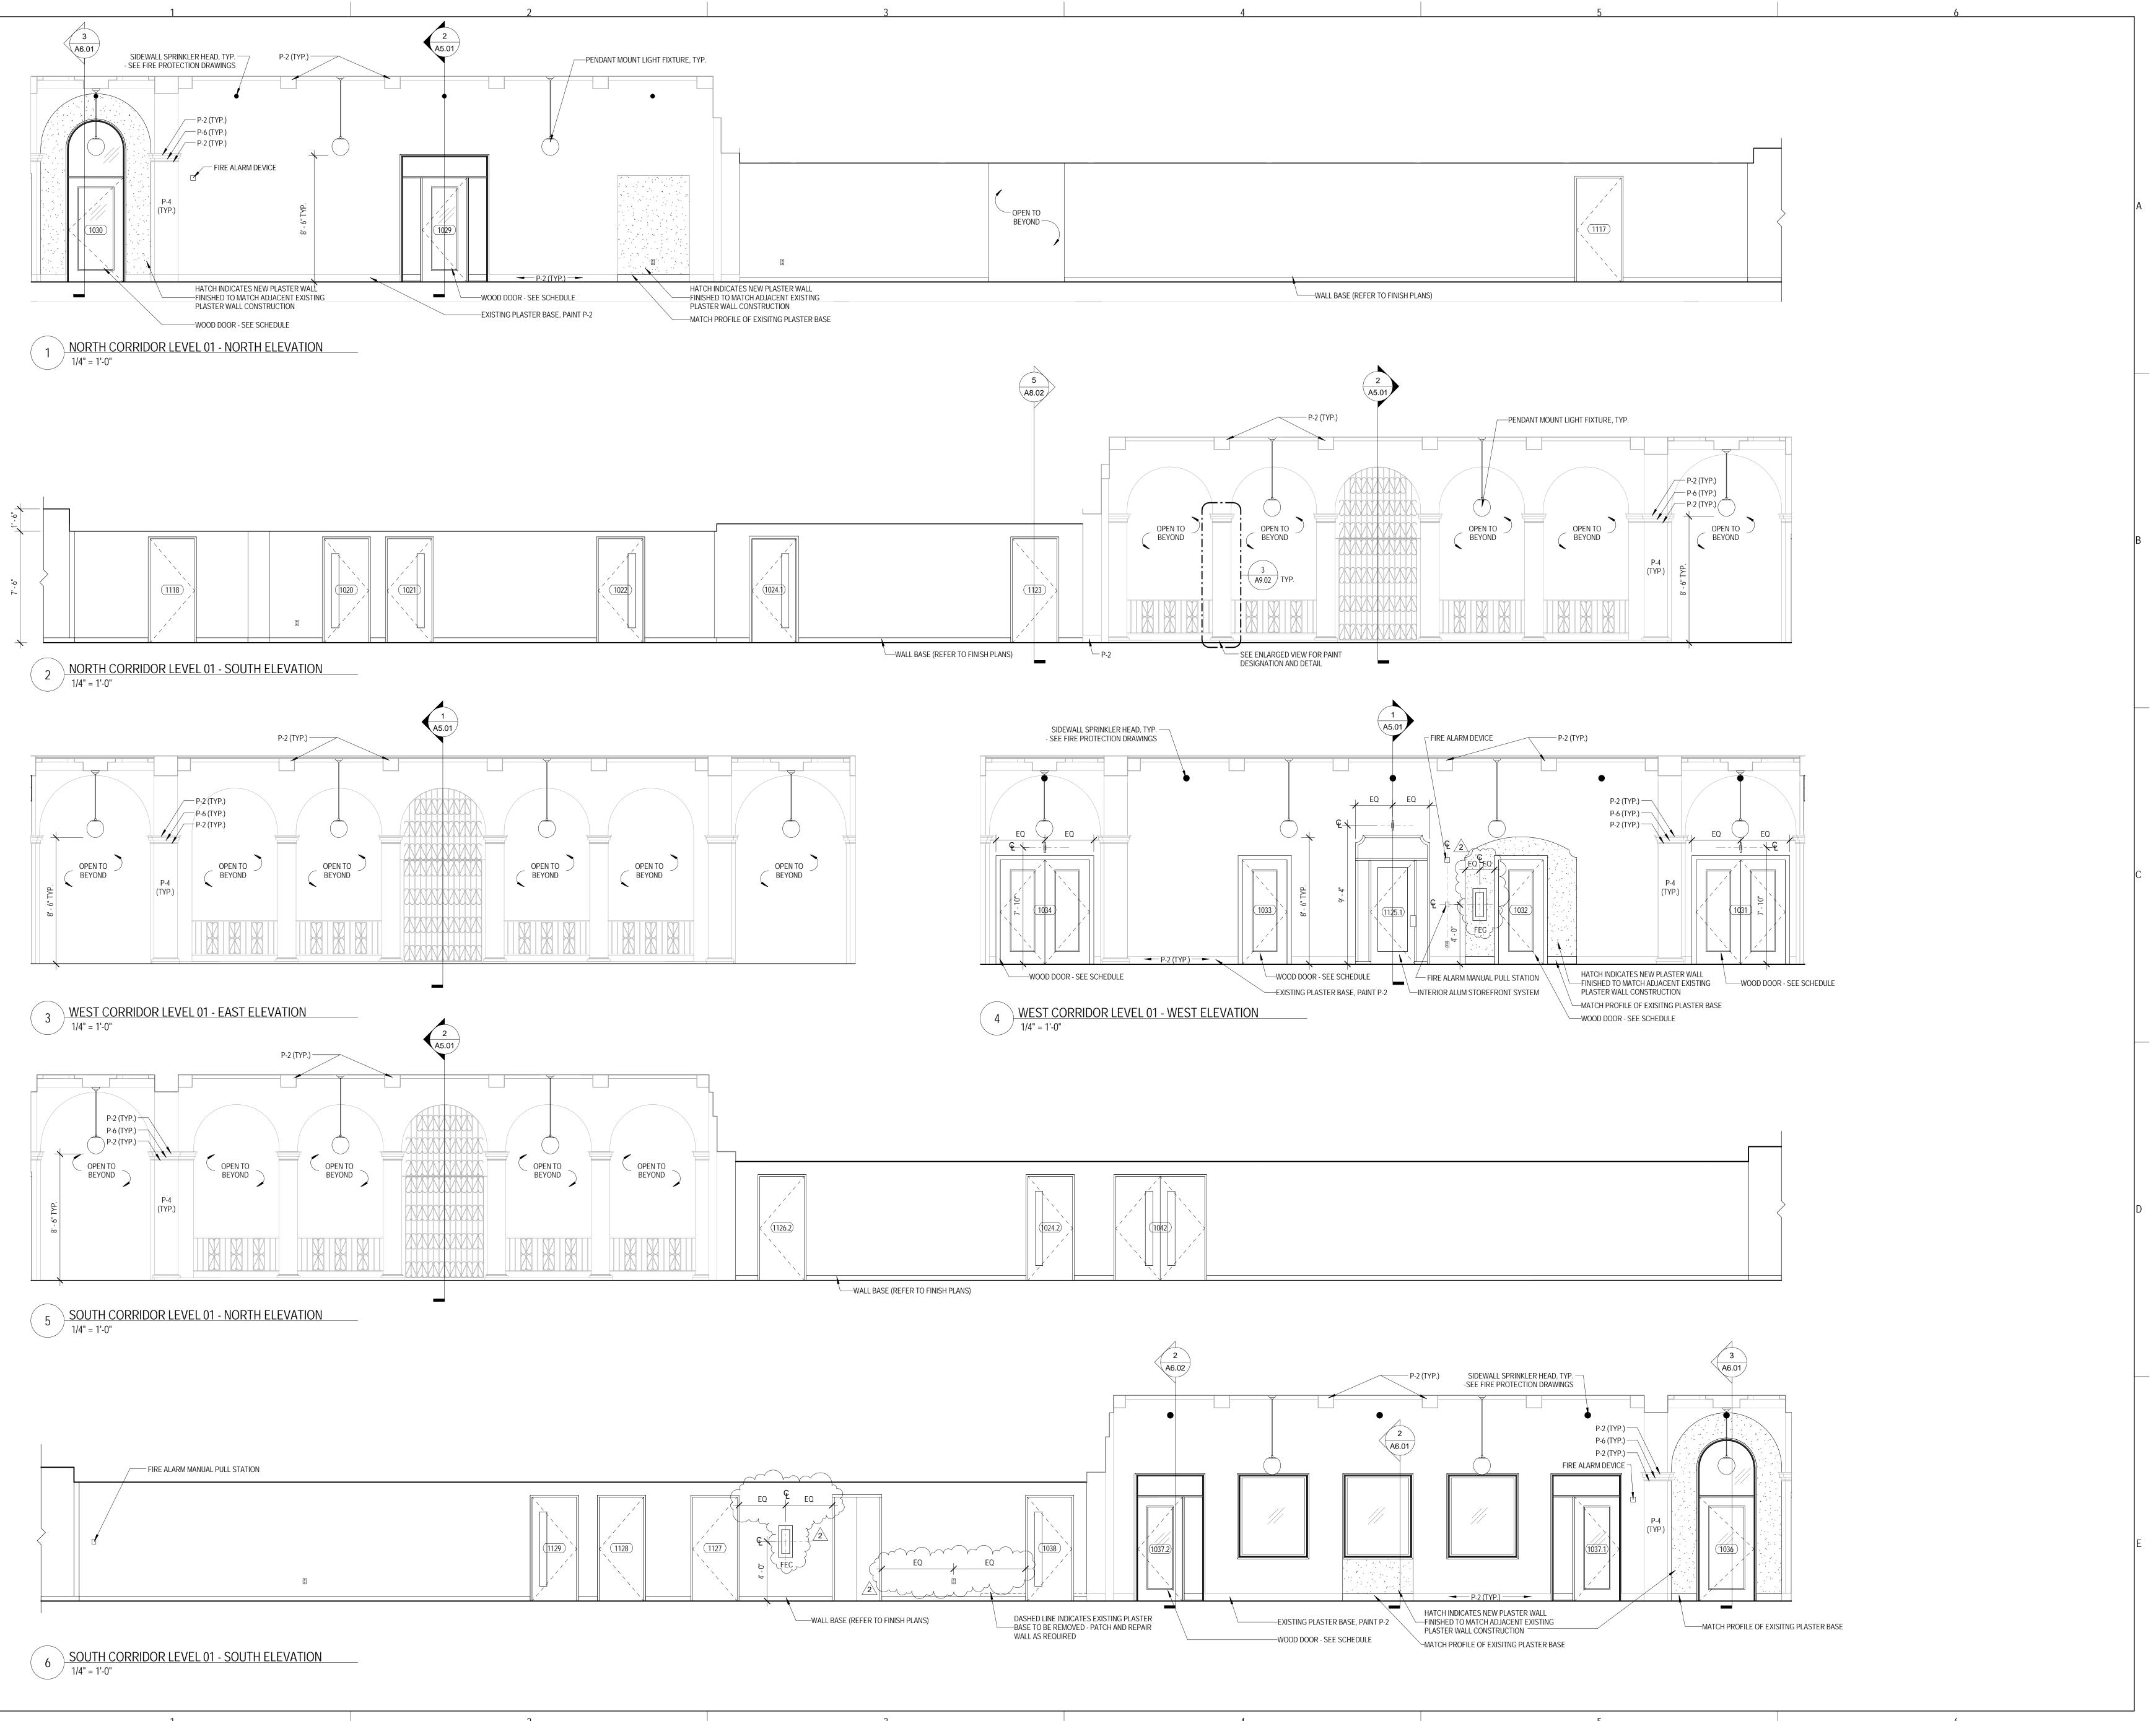
JOLIET JUNIOR COLLEGE RENAISSANCE CENTER RENOVATION PROJECT: 14-025

DATE: 02.26.16

REF SHEET: A1.21

Addendum 2

A121-01



STRUCTURAL & MEP/FP ENGINEERS KJWW ENGINEERING 1100 WARRENVILLE ROAD, #400W NAPERVILLE, IL 60563 T: 630.753.8553

FOOD SERVICE DESIGN CONSULTANTS **EF WHITNEY** 568 ANN ST. BIRMINGHAM, MI 48009

T: 248.644.0990 CIVIL ENGINEERS **RUETTIGER, TONELLI &** ASSOCIATES

129 CAPISTA DRIVE SHOREWOOD, IL 60404 T: 815.744.6600

KEY PLAN:


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DESCRIPTION: SHEET TITLE:

INTERIOR ELEVATIONS

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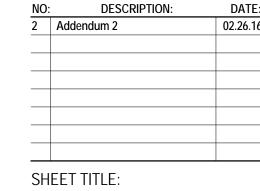
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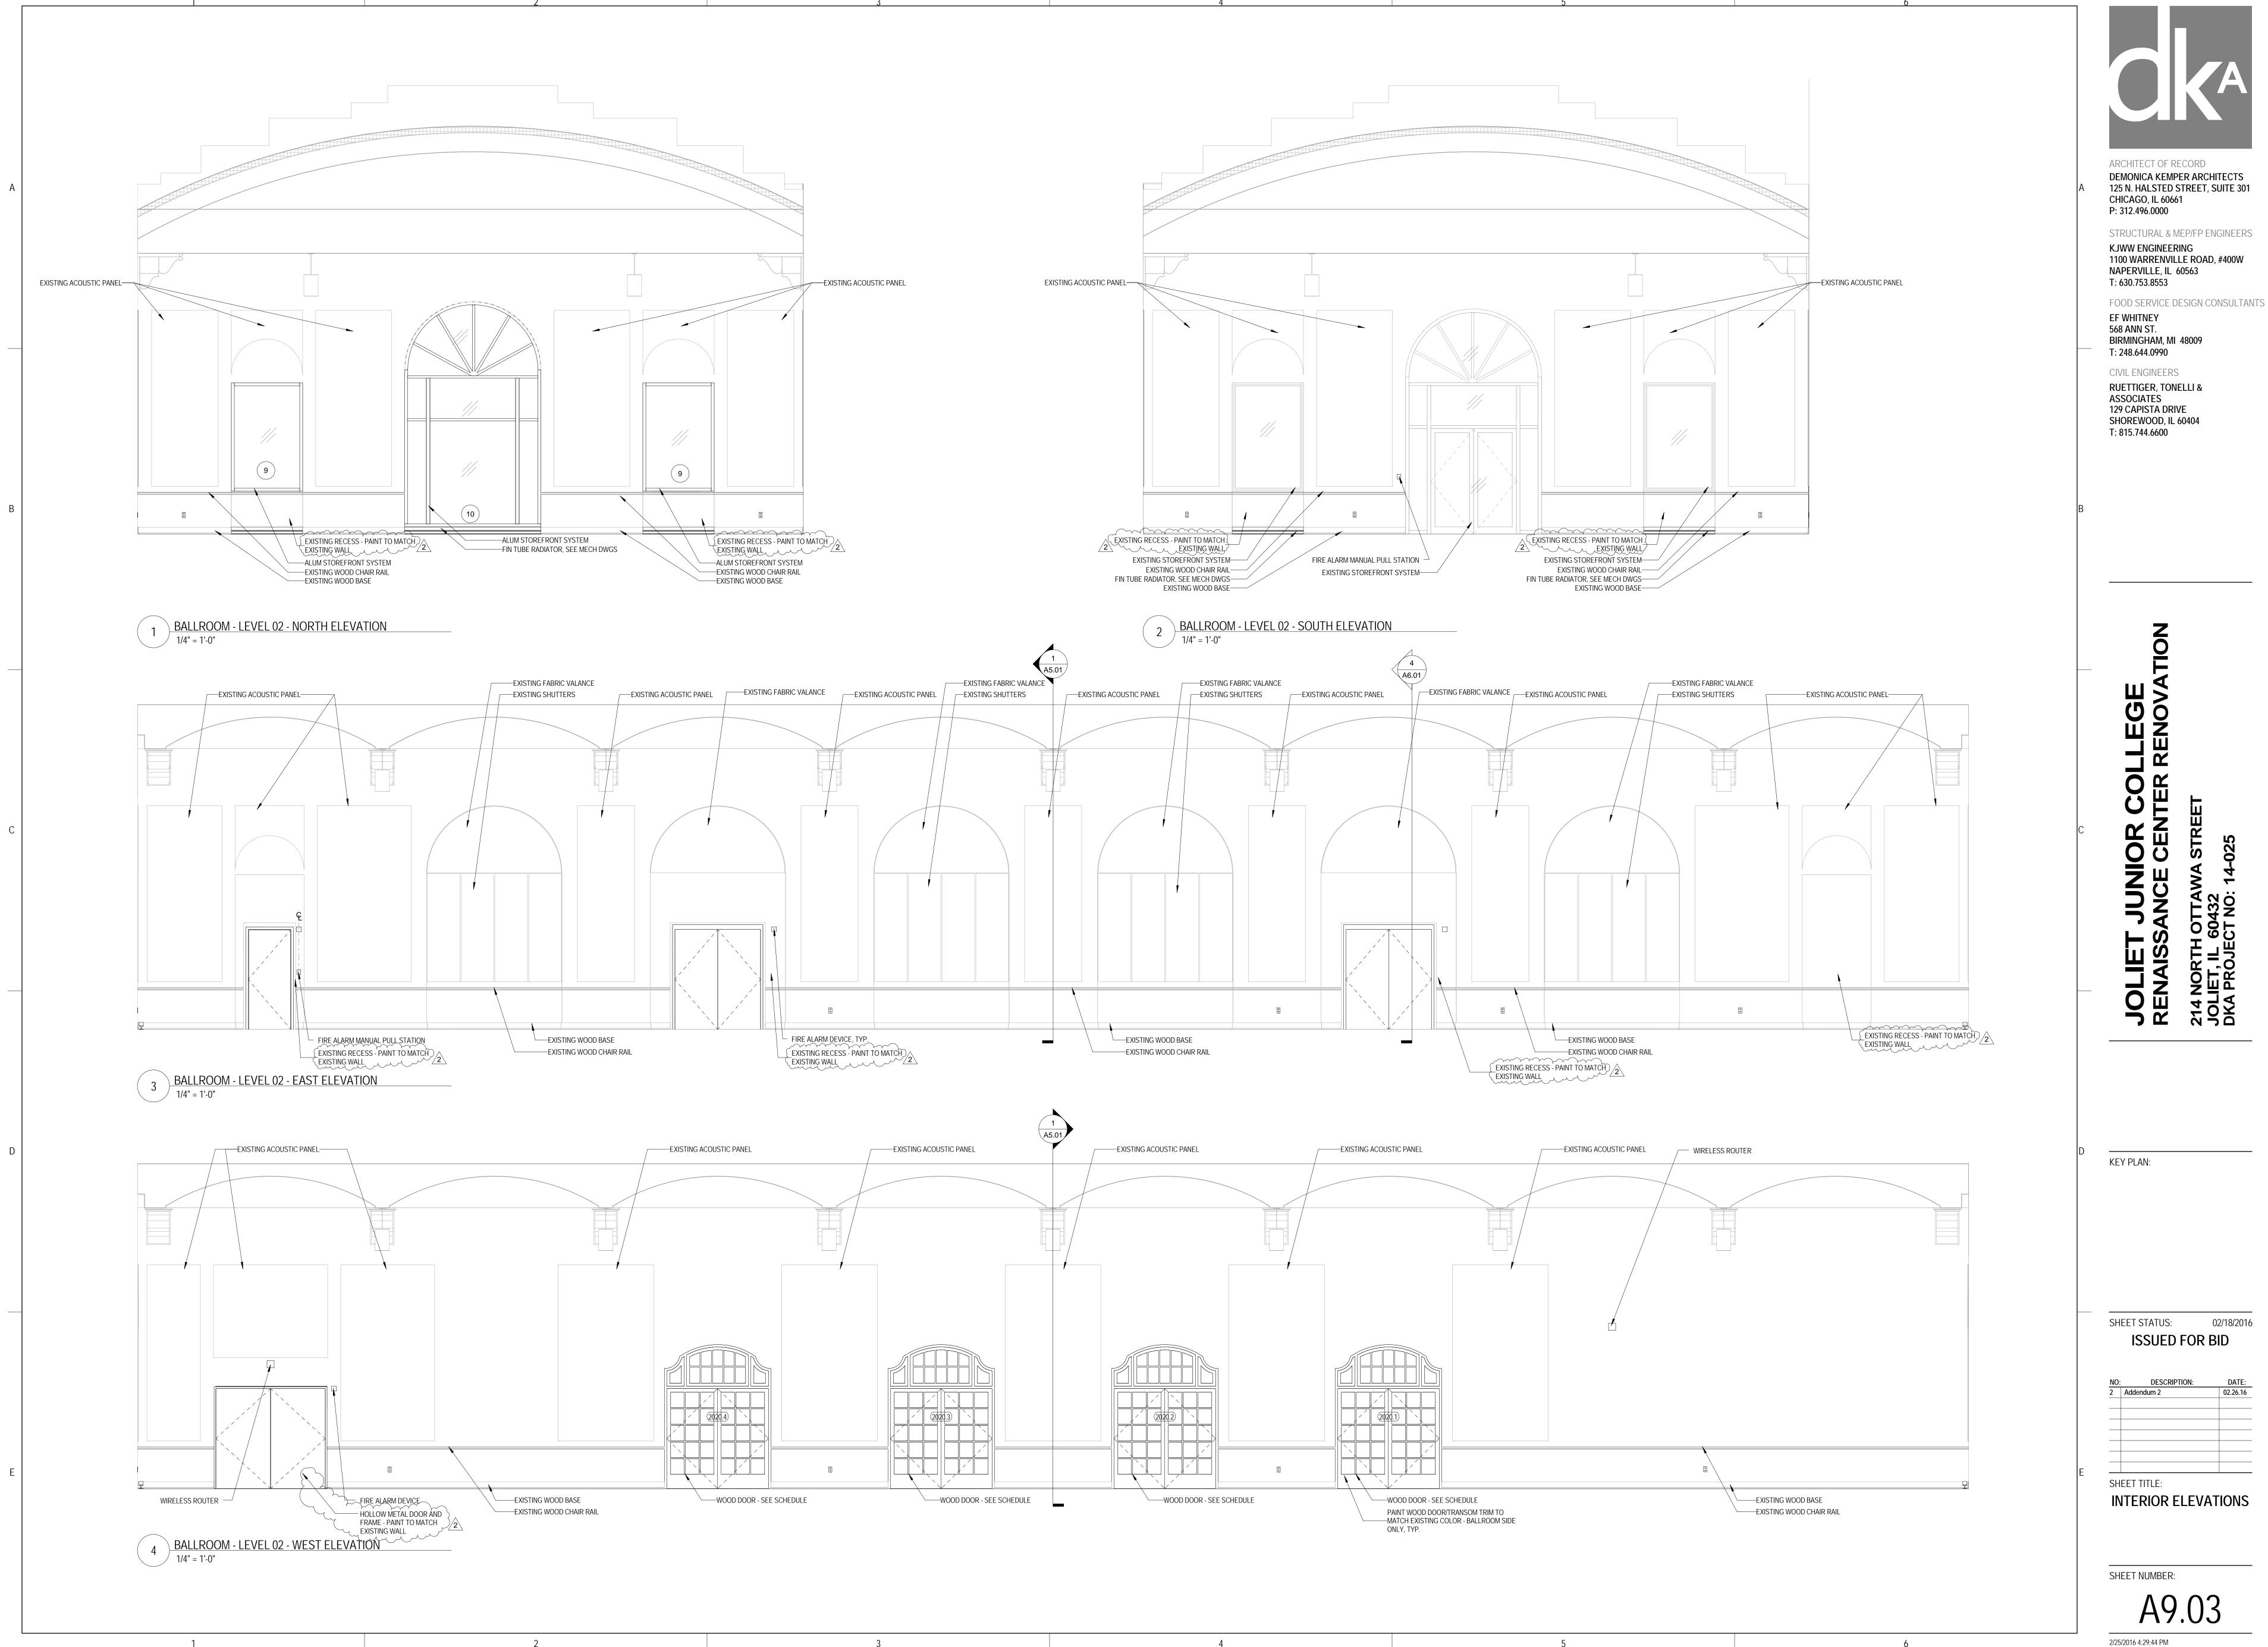
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**INTERIOR ELEVATIONS** 


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02/18/2016

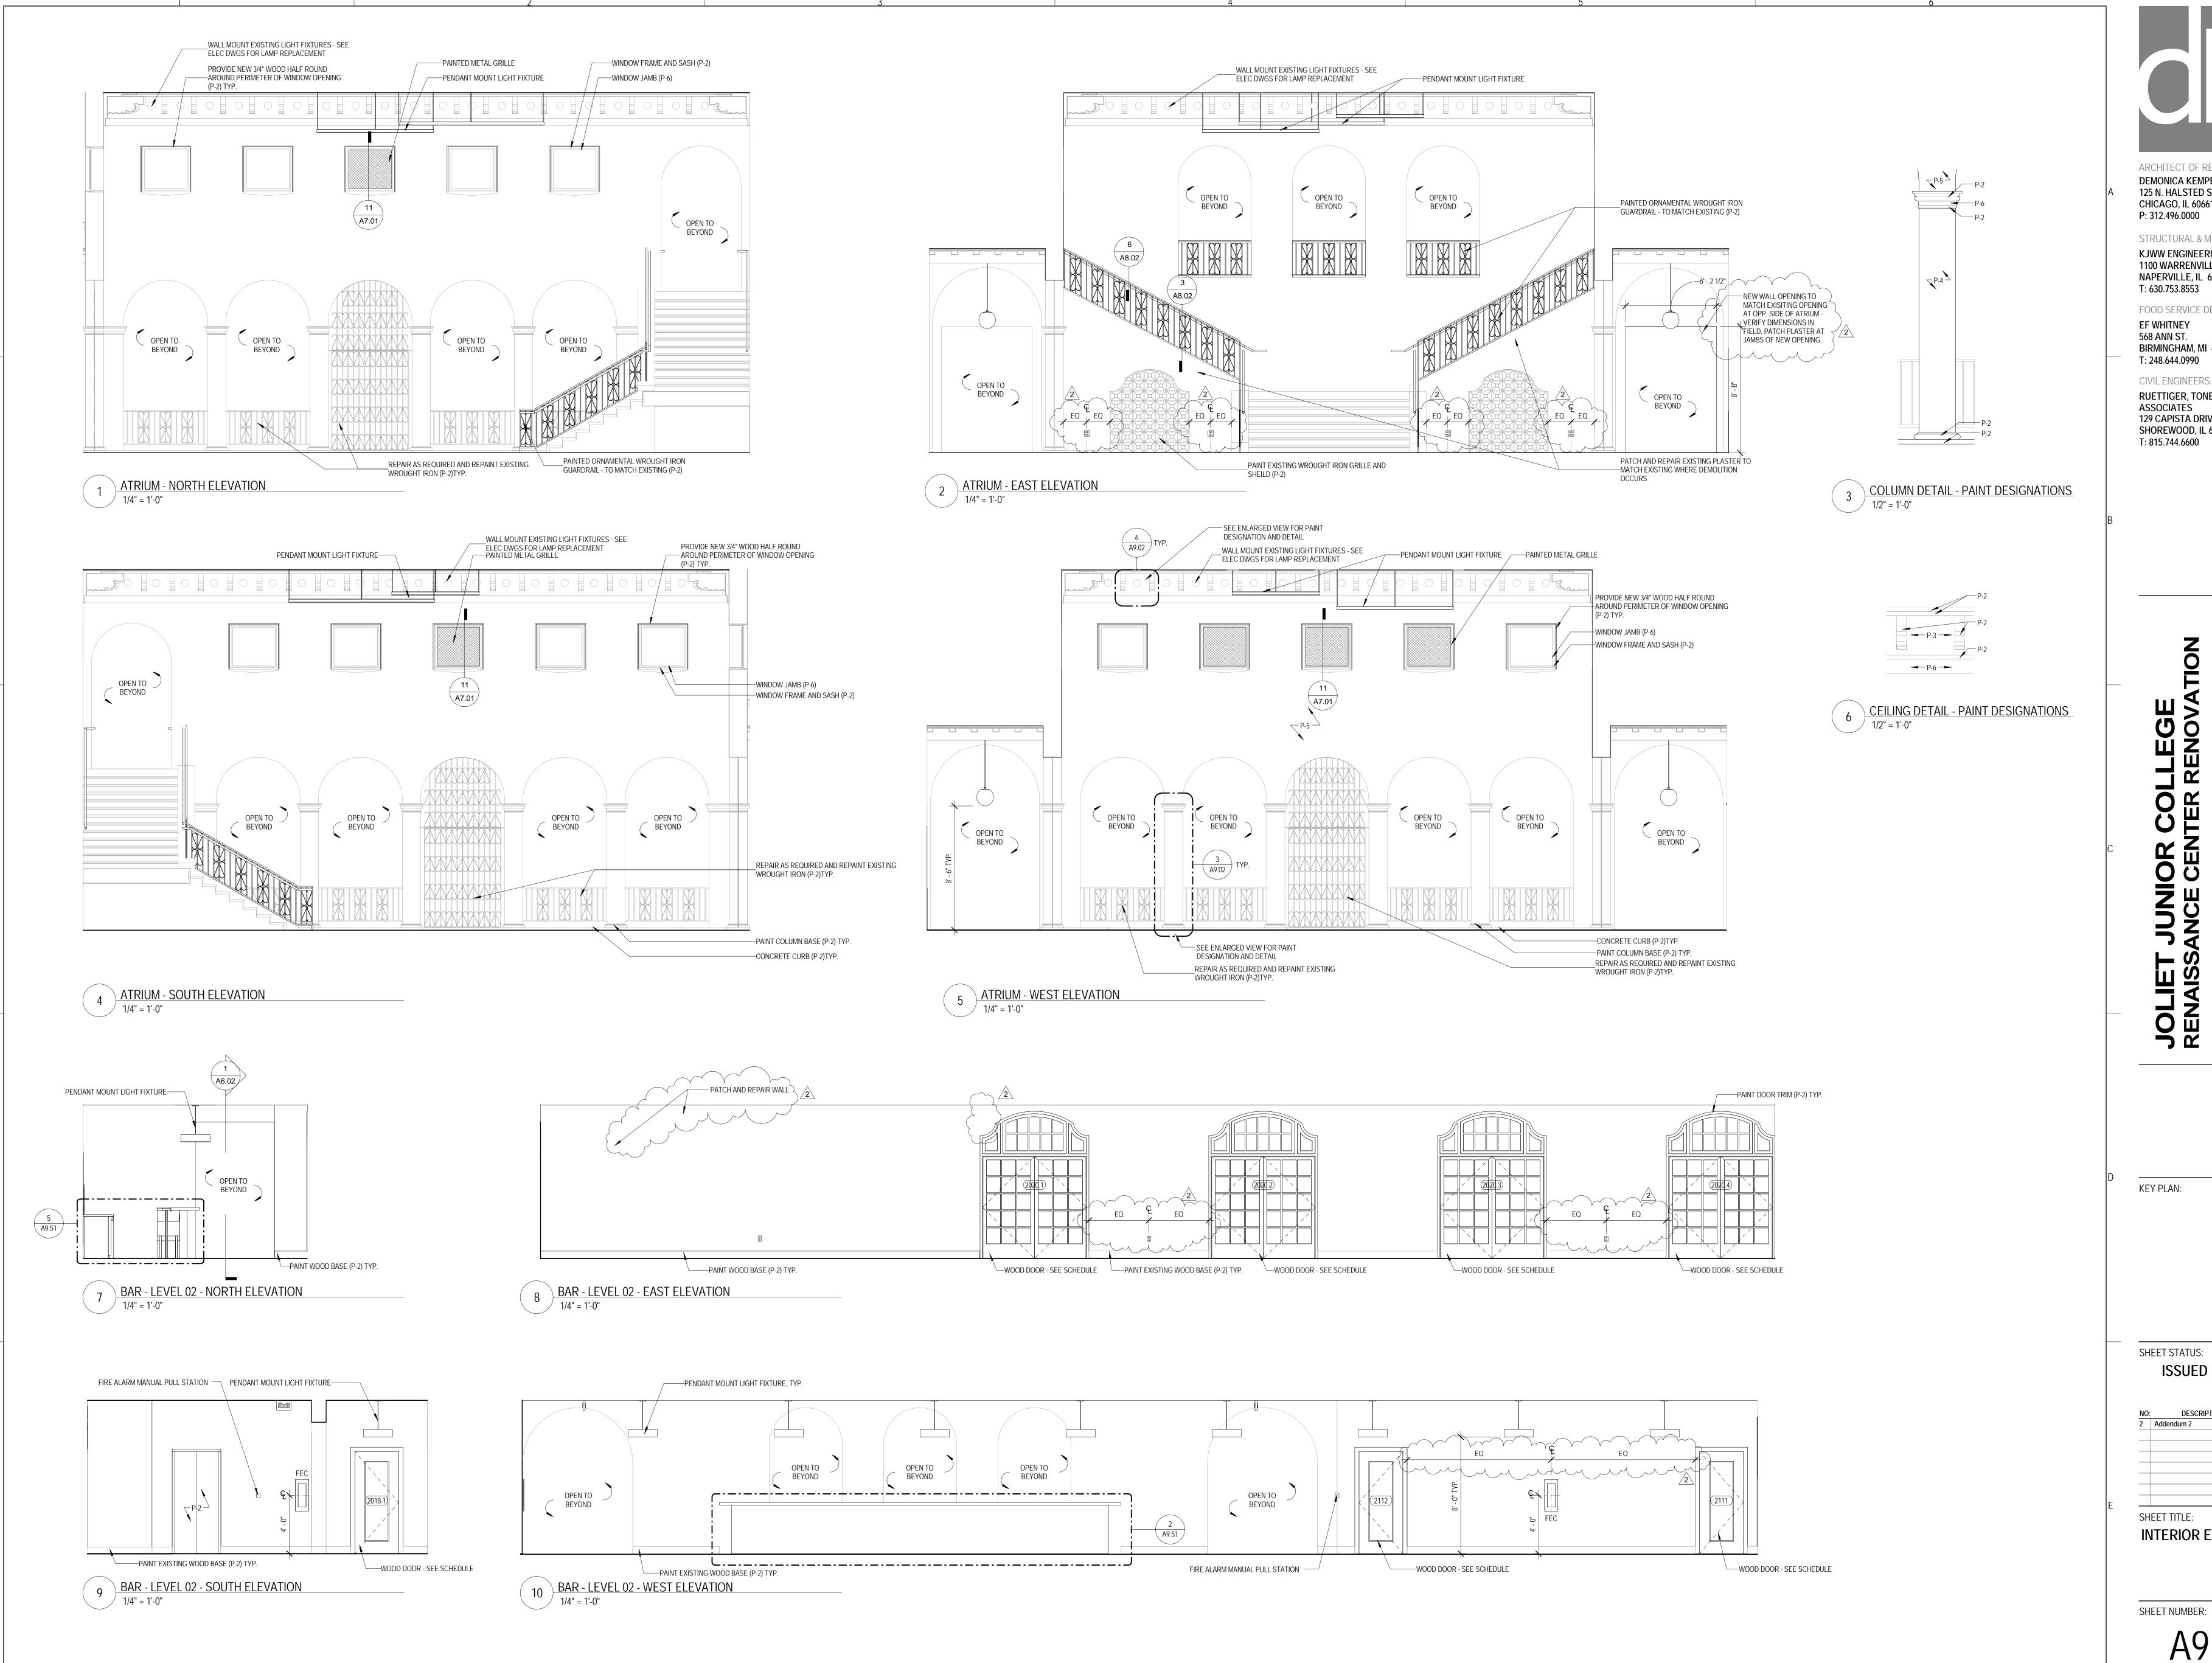

ADDITIONAL NUMBERED FRAME ELEVATIONS AND DETAILS ARE LOCATED ON THE WINDOW ELEVATION SHEET A10.10




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DATE: 02.26.16

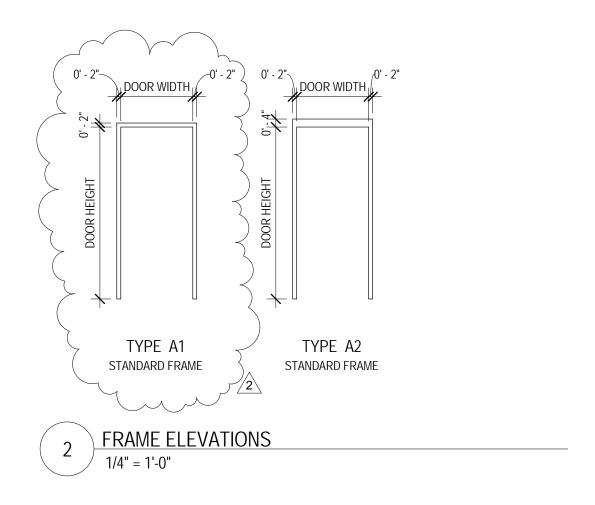REF SHEET: A10.00

Addendum 2

A1000-01



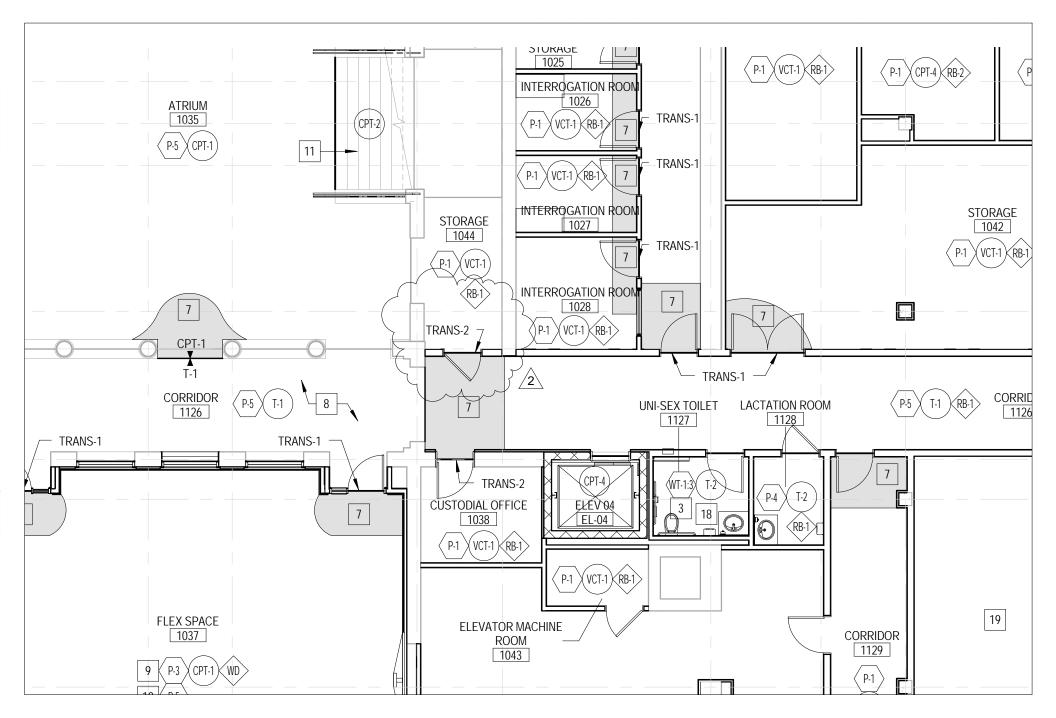


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DATE: 02.26.16

REF SHEET: A11.11

Addendum 2

A1111-01



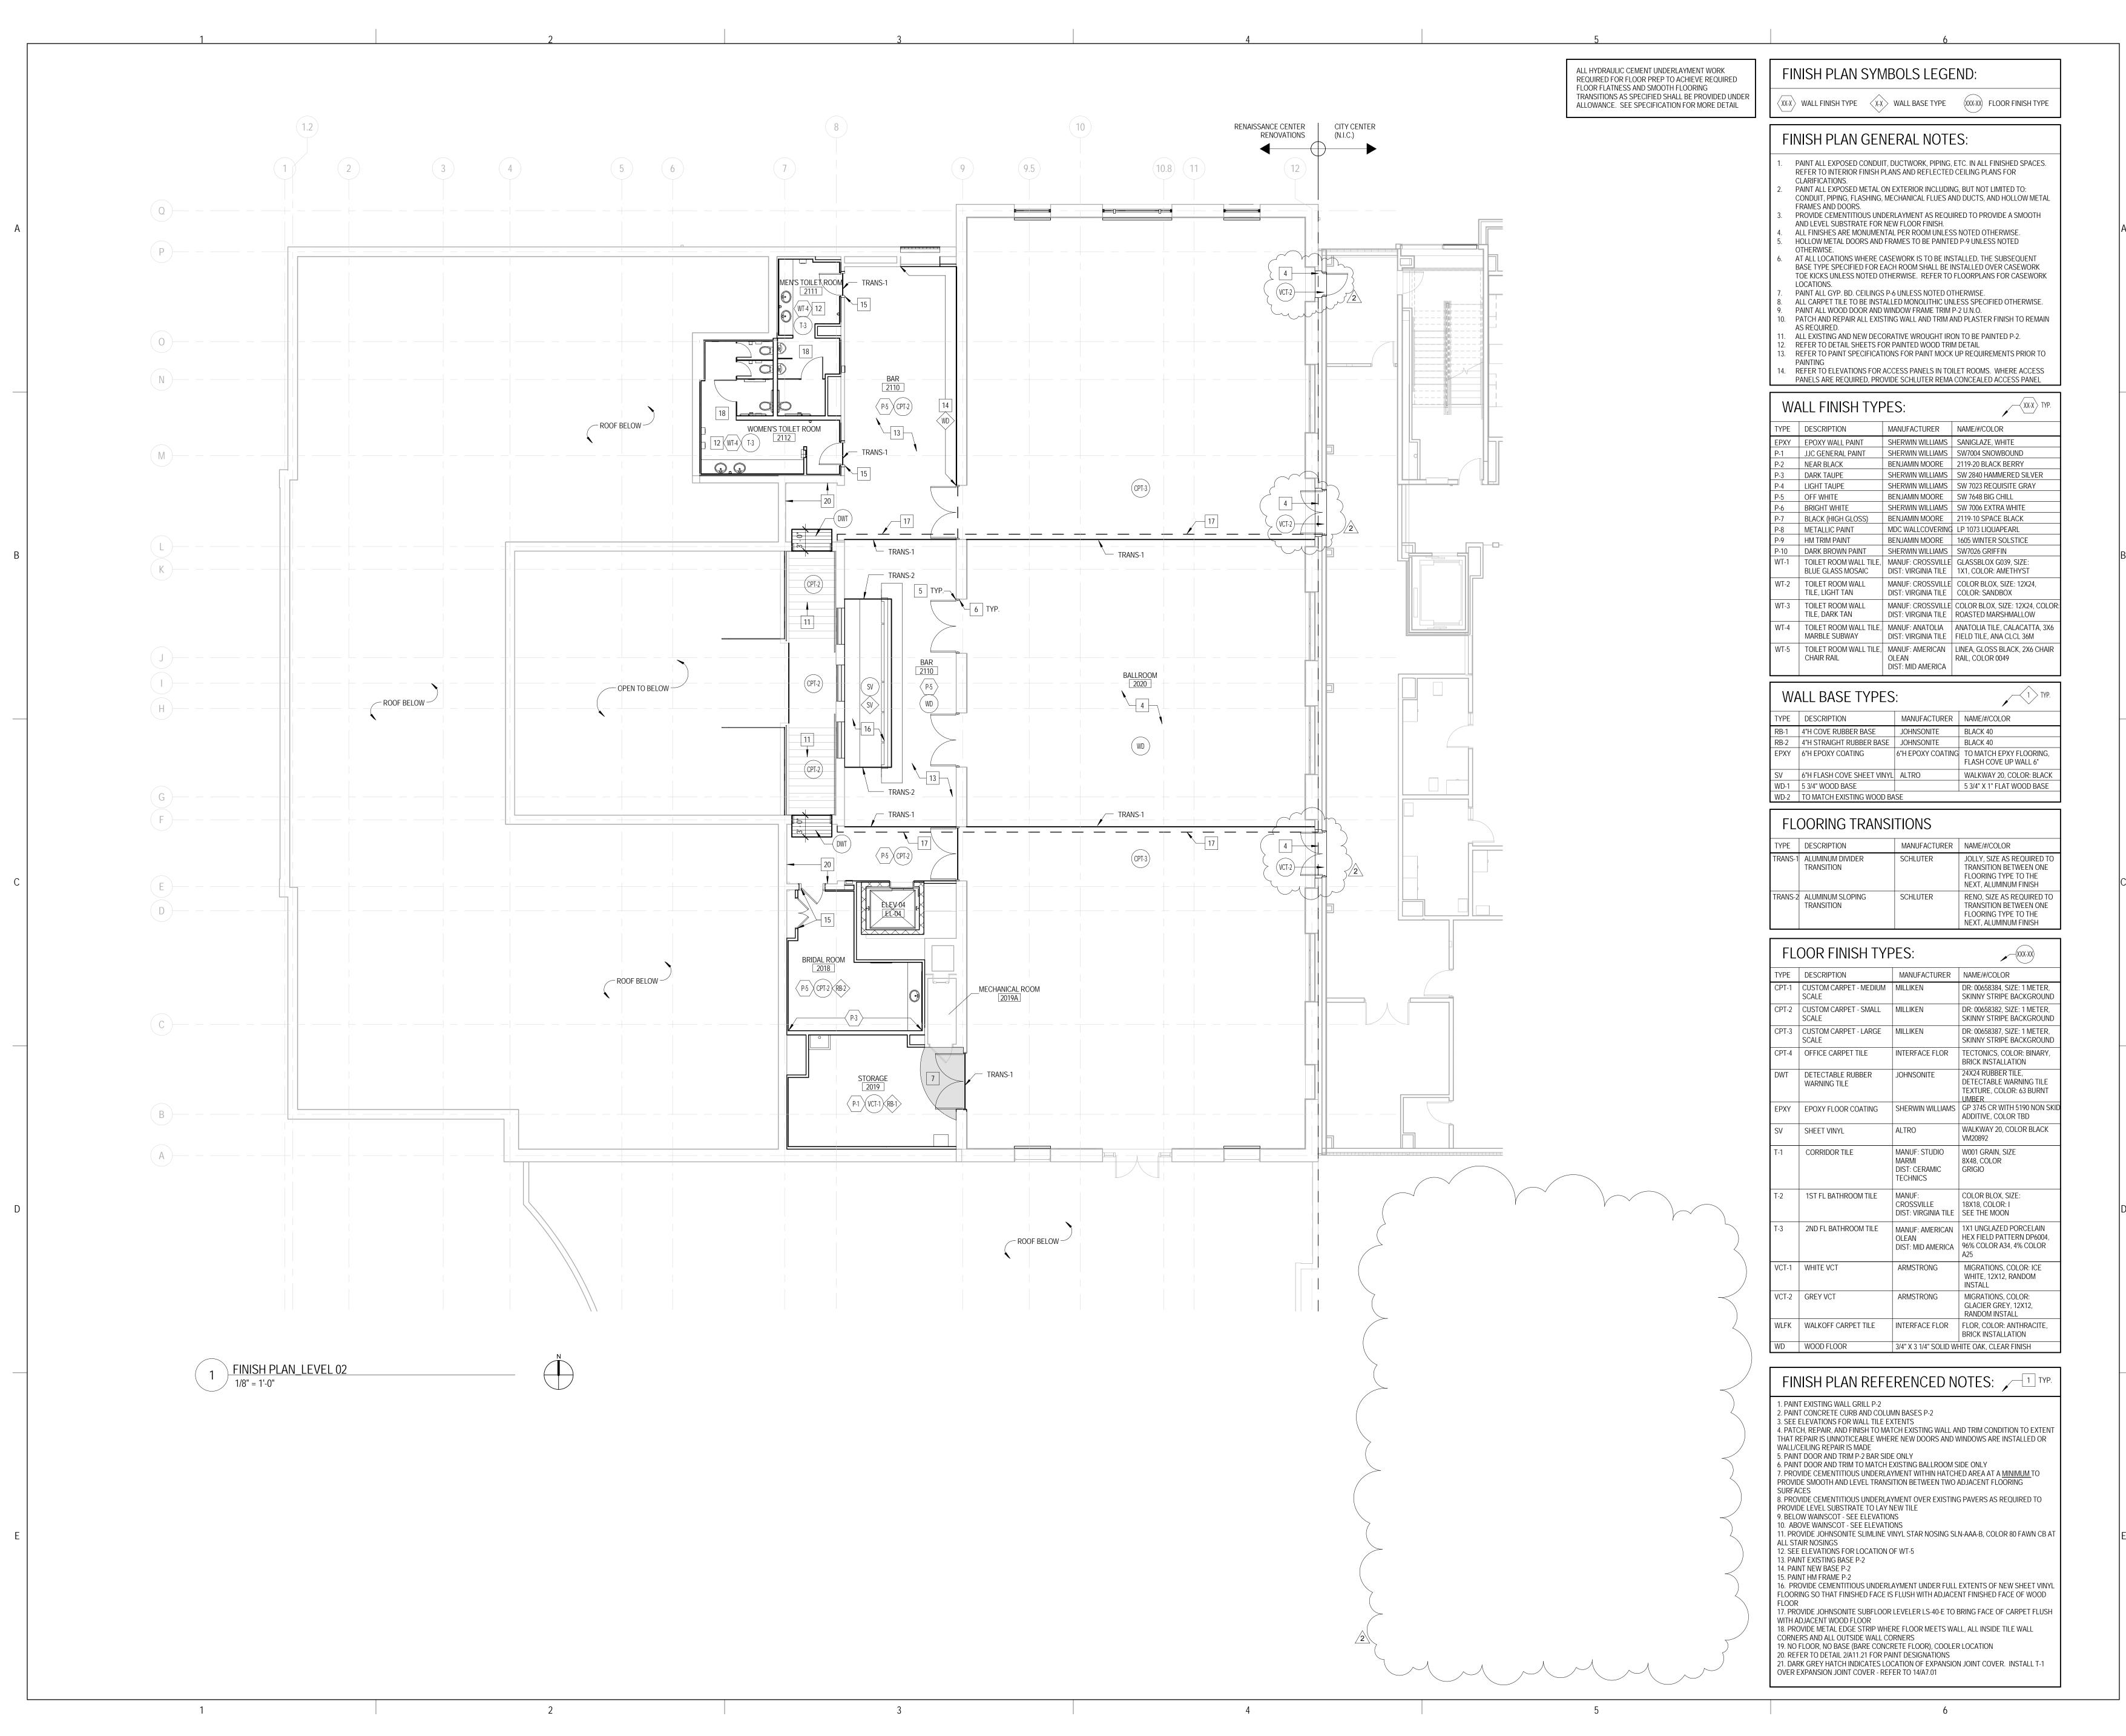

STRUCTURAL & MEP/FP ENGINEERS

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SANCE CENTER RENOVA

KEY PLAN:

SHEET STATUS: 02/18/2016


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NO:	DESCRIPTION:	DATE:
2	Addendum 2	02.26.16
SH	EET TITLE:	

LEVEL 2 - FINISH PLAN

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GENERAL MECHANICAL NOTES . PROVIDE ACOUSTICAL LAGGING ON ALL PIPING WITHIN THE CEILING SPACE OF THE ICE CARVING LAB. LAGGING SHALL BE CONTINUOUS WITH 2" OVERLAP OF ALL SEAMS AND A 2" OVERLAP AT WALL/CEILING PENETRATIONS. REFER TO SPECIFICATION SECTION 23 07 13 FOR LAGGING REQUIREMENTS.

KEYNOTES #

. NEW RADIATION SHALL BE FED FROM EXISTING PIPING. CONTRACTOR SHALL COORDINATE EXACT LOCATION OF PIPING PENETRATING THROUGH FLOOR IN FIELD. VERIFY WITH EXISTING WINDOW
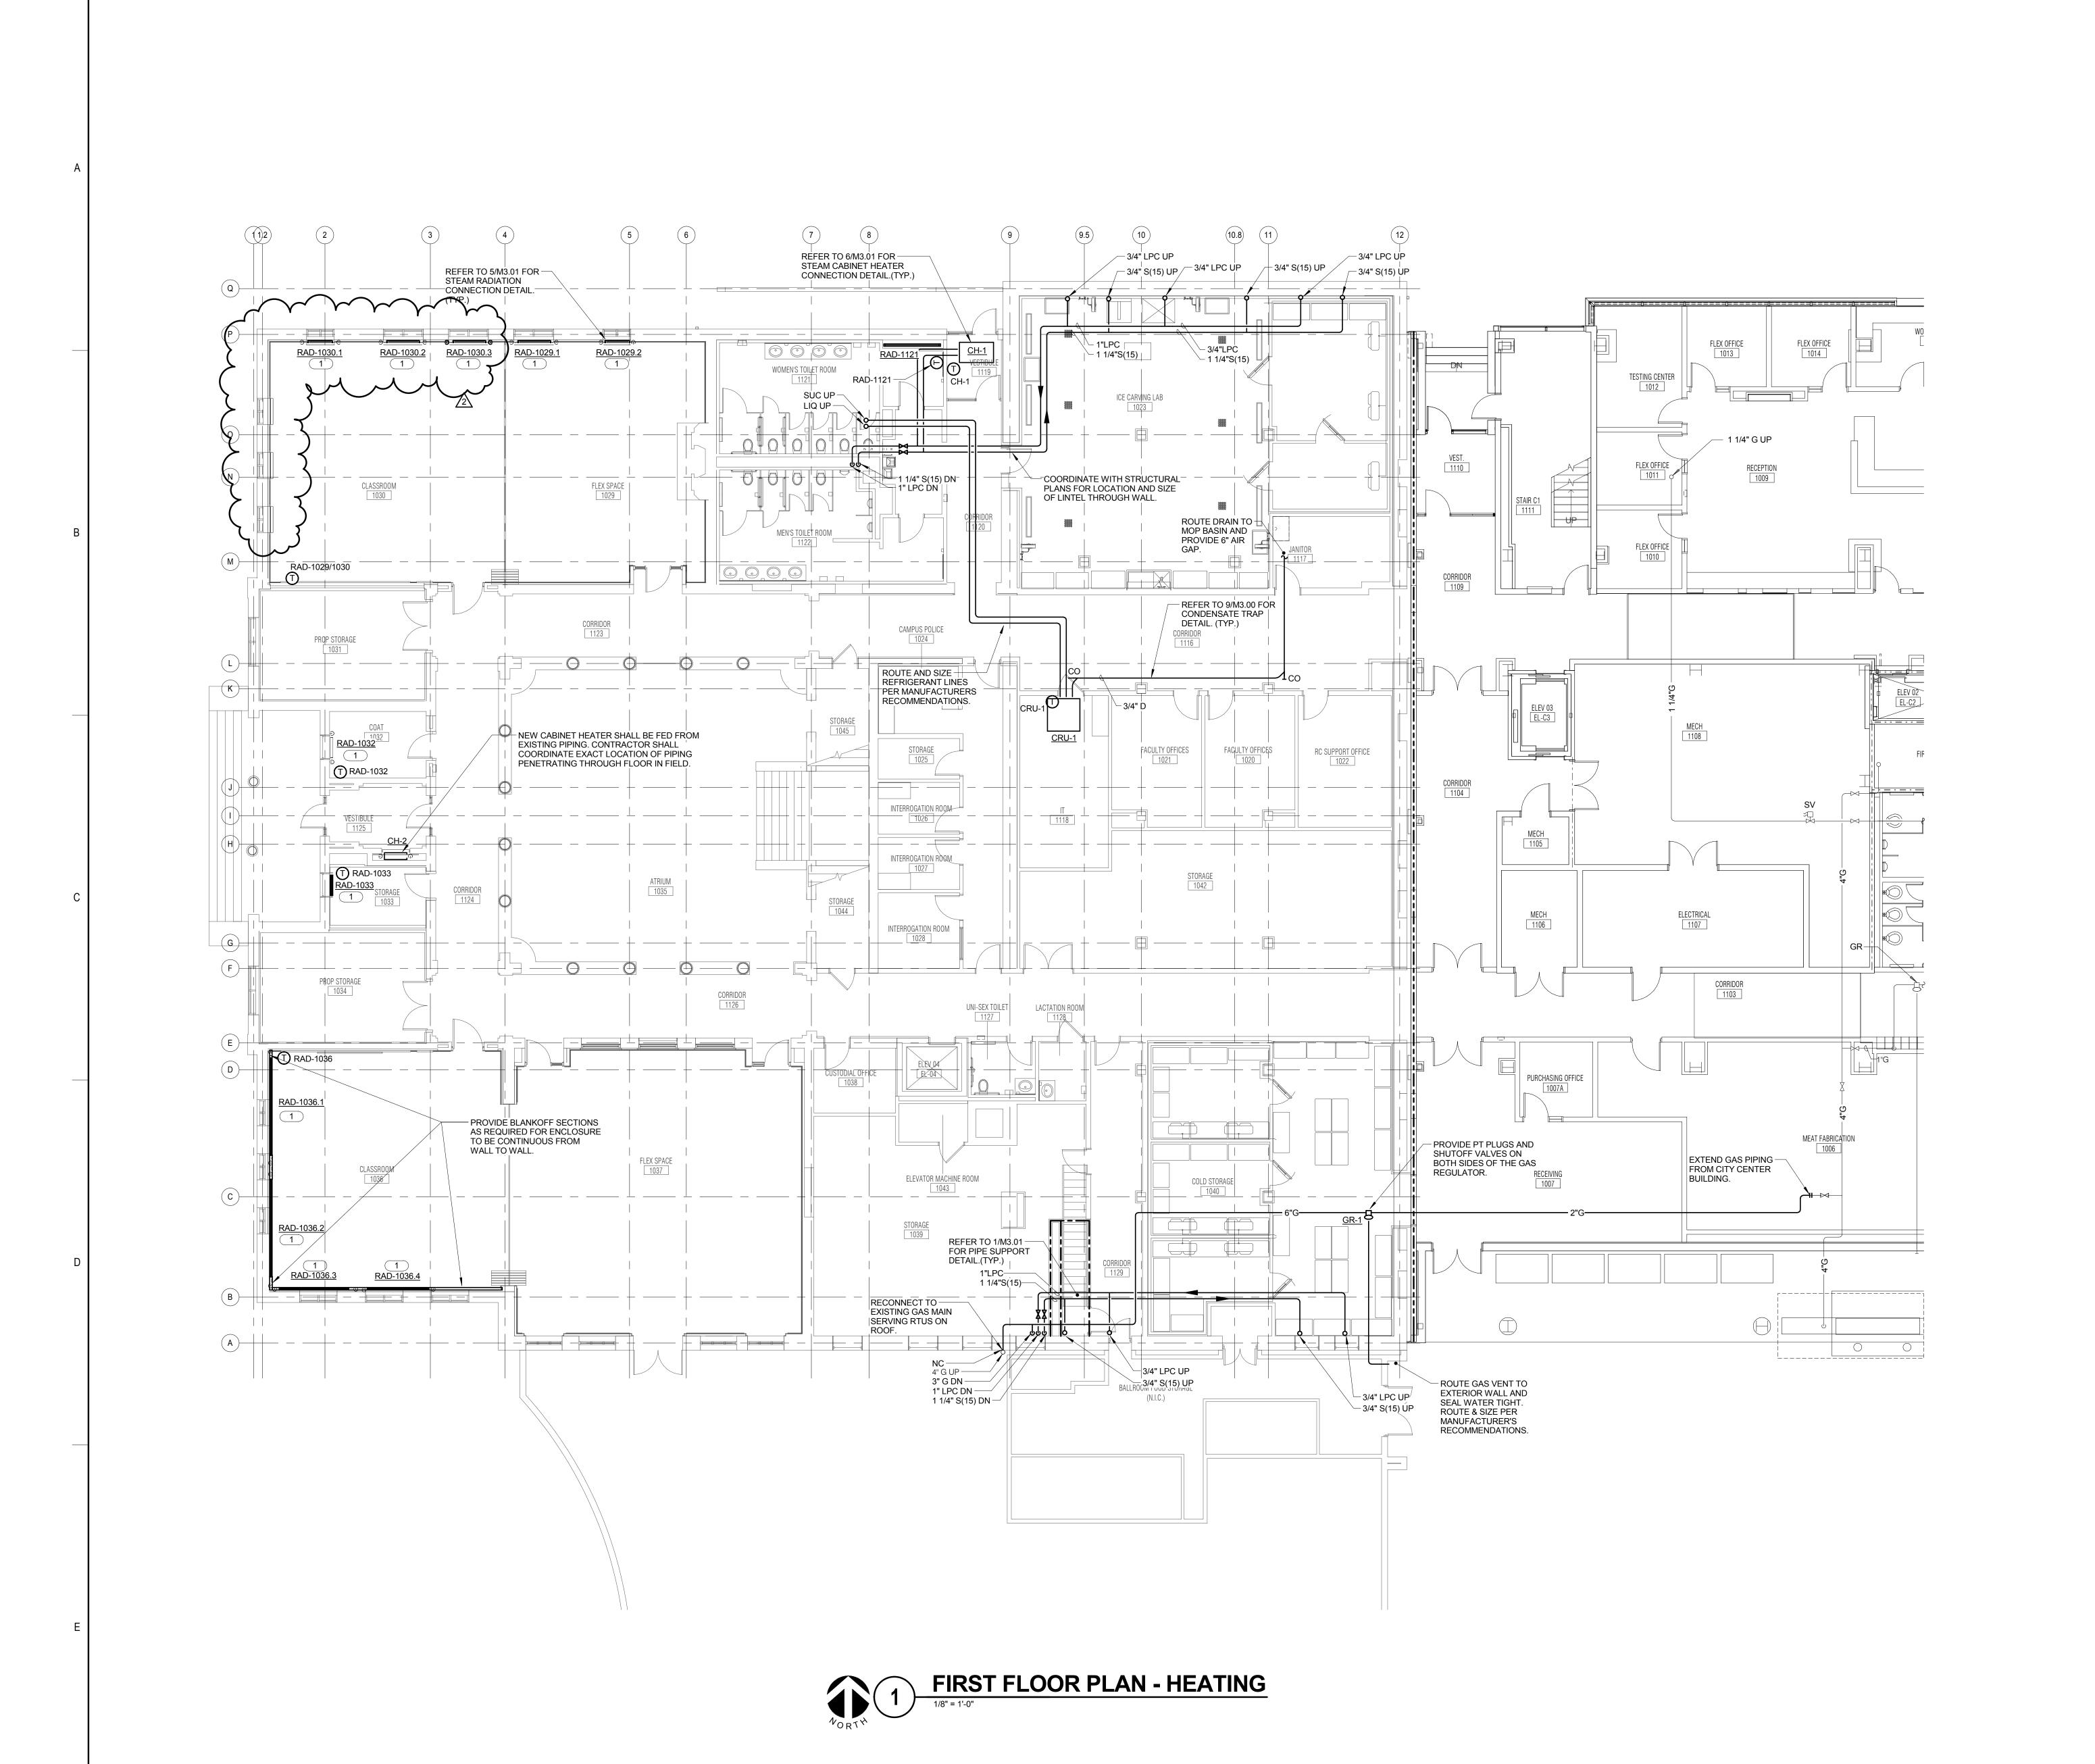
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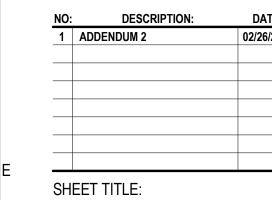
STRUCTURAL & MEP/FP ENGINEERS **KJWW ENGINEERING** 1100 WARRENVILLE ROAD, #400W NAPERVILLE, IL 60563 T: 630.753.8553

FOOD SERVICE DESIGN CONSULTANTS **EF WHITNEY** 568 ANN ST.

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KEY PLAN:

SHEET STATUS: **ISSUED FOR BID** 



FIRST FLOOR PLAN -**HEATING** 

SHEET NUMBER:

ENGINEERING
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1100 WARRENVILLE ROAD, SUITE 400W
NAPERVILLE, ILLINOIS 60563
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REFERENCE SCALE IN INCHES
1 2 \_\_\_\_

PROJECT # 15.0765.00

The FUTURE. Built SMARTER.®

NOTES: 1. MOUNT PER MANUFACTURER REQUIREMENTS.

2. UNIT SHALL INCLUDE AN ADJUSTABLE TIMER TO INITIATE DEFROST CYCLE. DEFROST CYCLE SHALL BE INITIATED IF THE SUCTION TEMPERATURE DROPS BELOW 30°F. DEFROST CYCLE SHALL BE LIMITED TO 10 MINUTES. HOT GAS BYPASS IS NOT ACCEPTABLE.

3. UNIT SHALL INCLUDE ALL NECESSARY CONTROLS AND COMPONENTS AS NECESSARY TO PROVIDE THE SCHEDULED DEHUMIDIFICATION CAPACITY WHILE REJECTING HEAT TO A MANUFACTURER REMOTE CONDENSER.

4. THE REMOTE CONDENSER SHALL BE PROVIDED BY THE DEHUMIDIFIER MANUFACTURER.

5. PROVIDE BACNET CARD TO INTERFACE WITH BAS AND REMOTE DISPLAY OPTION FOR CONTROLLER.

6. UNIT SHALL BE OUTDOOR RATED. 7. UNIT SHALL HAVE 4" PLEATED MERV 7 FILTERS.

8. UNIT SHALL BE ETL/UL LISTED. 9. UNIT MANUFACTURER SHALL PROVIDE START-UP.

COMPUTER ROOM UNIT SCHEDULE - DIRECT EXPANSION

					• .			_												
			EVT O.D.		REFRIGERA	NT COOLING	COIL		FILTERS						ELECTRICAL					
SYMBOL	SERVICE	CFM	EXT. S.P. IN. W.C.	COIL TYPE &	EA	<b>Λ</b> Τ	ľ	МВН	TYPE	ЦD	VOLT-	FLA/	MCA	MOCP	DISCONNECT	CONTROLLE	ER/STARTER	CONTROL DIAGRAM	MANUFACTURER	MODEL REMARKS
				REFRIGERANT	°FDB	°FWB	TOTAL	SENSIBLE	1166	ПР	PHASE	RLA	IVICA	AMPS	BY (NOTE A)	BY (NOTE A)	SCCR			
CRU-1	IT 1118	2,500	0.5	DX-R407C	72	63	64.5	61.5	MERV8	1.5	208-3	5.6	7.3	15.0	MFR	MFR	-	2/M4.00	LIEBERT	MMD60E

CONDENSING UNIT SCHEDULE

														ELECT	ΓRICAL					
SYMBOL	SERVICE	NOMINAL DESIGN	REFRIGERANT	AMBIENT	MINIMUM AMBIENT	NUMBER OF	NUMBER OF	NUMBER	NUMBER	VOLT	F1.4/		MOOD	DISC	ONNECT	CONTROLLER	R/STARTER	MANUFACTURER	MODEL	REMARKS
STIVIBOL	SERVICE	MBH	REFRIGERANT	TEMP. °F	TEMP. °F	COMPRESSORS	STAGES	CIRCUITS	FANS	VOLT- PHASE	FLA/ RLA	MCA	MOCP AMPS	BY (NOTE A)	TYPE (NOTE B)	BY (NOTE A)	SCCR	- WANDFACTURER	MODEL	REWARKS
CU-1	IT 1118	60	R407C	95	-30	1	1	1	1	460-3	10.9	13.4	20.0	MFR	NF	MFR	-	LIEBERT	PFHZ67AL7	
CU-2	RTU-3	125.8	R407C	95	-20	-	-	-	1	460-3	JL 2.Q.	4.0	ر 6.0 ہم	MFR	NF	MFR	10K	DESERT AIRE	RC5S032C	

CABINET HEATER SCHEDULE - STEAM

								ELECT	TRICAL					
SYMBOL	SERVICE	TYPE	NOMINAL	MBH	STEAM PSIG		VOLT	DISCO	ONNECT	CONTROLLER/	CONTROL DIAGRAM	MANUFACTURER	MODEL	REMARKS
OTWIDOL	GERVIOL	1112	CFM	IVIDIT	(NOTE 4)	FAN HP	VOLT/ PHASE	BY	TYPE	STARTER	OOMINGE BIAGINAM	WANTATIONER	WODEL	KEWAKKO
					, ,		111102	(NOTE A)	(NOTE B)	BY (NOTE A)				
CH-1	VESTIBULE-1119	HORIZONTAL RECESSED	550	33.9	2	1/9	120-1	MFR	NF	BAS	1/M4.01	TRANE	MODEL E	NOTE 1, 2, 3
CH-2	VESTIBULE-1125	VERTICAL CABINET	500	32.4	2	1/9	120-1	MFR	NF	BAS	1/M4.01	TRANE	MODEL M	NOTE 1, 2, 5, 6

NOTES:

1. COORDINATE COLOR SELECTION WITH ARCHITECT.

2. SET UNIT FAN ON HIGH SPEED. PROVIDE FAN SPEED SELECTOR. 3. UNIT SHALL HAVE BOTTOM STAMPED LOUVER FOR INLET AND OUTLET.

4. STEAM PRESSURE IS PRESSURE DOWNSTREAM FROM CONTROL VALVE.

5. UNIT SHALL HAVE FRONT STAMPED LOUVER FOR INLET AND OUTLET.

6. PROVIDE UNIT MOUNTED THERMOSTAT.

FAN SCHEDULE

	TILDOLL																		
			S.P.	WHEEL	FAN		MAX.		CURB				ELECT	RICAL					
SYMBOL	SERVICE	CFM	IN.	DIA.	RPM	DRIVE	AMCA	BACKDRAFT DAMPER	TYPE	BHP	MHP	VOLT-	DISCO	ONNECT	CONTROLLER/STARTER	CONTROL DIAGRAM	MANUFACTURER	MODEL	REMARKS
			W.C.	INCHES	(NOTE F)		SONES	<i>57</i> 2. (	(NOTE G)	(NOTE E)	(NOTE E)	PHASE	BY (NOTE A)	TYPE (NOTE B)	TYPE (NOTE C)	Dir tor u uv			
EF-1	RESTROOM	2,150	0.75	15.0	1,308	BELT	16.2	ELECTRIC	MFR	0.55	0.75	120-1	MFR.	NF	BAS	2/M4.01	COOK	150ACWB	
EF-2	ICE CARVING LAB	200	0.3	7.0	1,314	BELT	7.5	ELECTRIC	MFR	0.09	0.167	120-1	MFR.	NF	BAS	6/M4.01	COOK	70ACEB	
EF-3	BAR	1,350	0.3	15.0	827	BELT	5.7	ELECTRIC	MFR	0.15	0.25	120-1	MFR.	NF	BAS	6/M4.01	COOK	150ACEB	

PEDESTAL

PEDESTAL

4/M4.01

4/M4.01

VULCAN

VULCAN

JV4-AR-PM NOTE 1, 2, 3.

JV4-AR-PM NOTE 1, 2, 3.

JV4-AR-PM NOTE 1, 2, 3.

RADIAT	TION SCHEDULE	E - STEA	AM											
					ELEN	MENT			STEAM		CONTROL			
SYMBOL	SERVICE	MBH/FT	MATERIAL	LENGTH (FT.)	PIPE SIZE	FIN HEIGHT & WIDTH	NO. OF ROWS	FINS PER FT	PSIG (NOTE 1)	STYLE	DIAGRAM	MANUFACTURER	MODEL	REMARKS
RAD-1121	WOMEN"S TOILET 1121	1.69	COPPER	5	1"	4-1/4" x 3-5/8"	1	40	2	WALL MOUNTED	4/M4.01	VULCAN	JV4-AR	NOTE 1, 2, 3.
RAD-1029.1	FLEX SPACE 1029	1.45	COPPER	4	1"	4-1/4" x 3-5/8"	1	40	2	PEDESTAL	4/M4.01	VULCAN	JV4-AR-PM	NOTE 1, 2, 3.
RAD-1029.2	FLEX SPACE 1029	1.45	COPPER	3	1"	4-1/4" x 3-5/8"	1	40	2	PEDESTAL	4/M4.01	VULCAN	JV4-AR-PM	NOTE 1, 2, 3.
-RAD 183D1	CLASSROOM 1030	1.45	COPPER	2 ~	1"	4-1/4" x 3-5/8"	1	40	2	PEDESTAL	4/M4.01	VULCAN	JV4-AR-PM	NOTE 1, 2, 3.
RAD-1030.2	CLASSROOM 1030	1.45	COPPER	<b>4</b>	1"	4-1/4" x 3-5/8"	1	40	2	PEDESTAL	4/M4.01	VULCAN	JV4-AR-PM	NOTE 1, 2, 3.
RAD-1030.3	CLASSROOM 1030	1.45	COPPER	4 3	1"	4-1/4" x 3-5/8"	1	40	2	PEDESTAL	4/M4.01	VULCAN	JV4-AR-PM	NOTE 1, 2, 3.
RAD-1032	COAT 1032	1.45	COPPER	2.5	1"	4-1/4" x 3-5/8"	1	40	2	PEDESTAL	4/M4.01	VULCAN	JV4-AR-PM	NOTE 1, 2, 3.
CEOP-CAST	COAT 1033	1.45	COPPER	2.5	1"	4-1/4" x 3-5/8"	1	40	2	PEDESTAL	4/M4.01	VULCAN	JV4-AR-PM	NOTE 1, 2, 3.
RAD-1036.1	CLASSROOM 1036	1.69	COPPER	12	1"	4-1/4" x 3-5/8"	1	40	2	WALL MOUNTED	4/M4.01	VULCAN	JV4-AR	NOTE 1, 2, 3.
RAD-1036.2	CLASSROOM 1036	1.69	COPPER	12	1"	4-1/4" x 3-5/8"	1	40	2	WALL MOUNTED	4/M4.01	VULCAN	JV4-AR	NOTE 1, 2, 3.
RAD-1036.3	CLASSROOM 1036	1.69	COPPER	8.5	1"	4-1/4" x 3-5/8"	1	40	2	WALL MOUNTED	4/M4.01	VULCAN	JV4-AR	NOTE 1, 2, 3.
RAD-1036.4	CLASSROOM 1036	1.69	COPPER	7.5	1"	4-1/4" x 3-5/8"	1	40	2	WALL MOUNTED	4/M4.01	VULCAN	JV4-AR	NOTE 1, 2, 3.
RAD-2020.1	BALLROOM 2020	1.45	COPPER	4.5	1"	4-1/4" x 3-5/8"	1	40	2	PEDESTAL	4/M4.01	VULCAN	JV4-AR-PM	NOTE 1, 2, 3.
RAD-2020 2	BALLROOM 2020	1 45	COPPER	9	1"	4-1/4" x 3-5/8"	1	40	2	PEDESTAL	4/M4 01	VUI CAN	.IV4-AR-PM	NOTE 1 2 3

RAD-2020.3

RAD-2020.4

1. STEAM PRESSURE INDICATED IS THE PRESSURE AVAILABLE DOWNSTREAM OF THE CONTROL VALVE.

1.45

1.45

2. PROVIDE NEW BRACKETS, ETC FOR INSTALLATION OF FIN-TUBE.

BALLROOM 2020

BALLROOM 2020

3. MOUNT FIN-TUBE HIGH ENOUGH IN CUSTOM ENCLOSURE TO ALLOW FOR INSTALLATION OF STEAM TRAP WITH-IN ENCLOSURE.

COPPER

COPPER

GRILLES REGISTERS & DIFFUSERS SCHEDULE

SYMBOL	MATERIAL	TYPE	MARGIN (NOTE 1)	INLET SIZE (INCH)	FACE SIZE (INCH)	VOLUME DAMPER REQUIRED	FINISH	MANUFACTURER	MODEL	REMARKS
CD-1	STEEL	PANEL FACE	LAY-IN	SEE DWG.	24x24	NO	WHITE	TITUS	OMNI	FLUSH FACE PANEL
CD-2	STEEL	PANEL FACE	LAY-IN	SEE DWG.	12x12	NO	WHITE	TITUS	OMNI	FLUSH FACE PANEL
RG-1	STEEL	PERFORATED FACE	LAY-IN	SEE DWG.	24x24	NO	WHITE	TITUS	RAP	DUCTED RETURN
RG-2	STEEL	PERFORATED FACE	LAY-IN	N/A	12x12	NO	WHITE	TITUS	PAR	PROVIDE 12x12 WITH LIGHT SHIELD
TG-1	STEEL	PERFORATED FACE	LAY-IN	SEE DWG.	24x24	NO	WHITE	TITUS	PART	BUCKED NEITHAN COMMENT
EG-1	STEEL	PERFORATED FACE	LAY-IN	SEE DWG.	24x24	NO	WHITE	TITUS	PAR	DUCTED RETURN
EG-2	STEEL	35° DEFLECTION	1 1/4"	SEE DWG.	INLET +2	NO	WHITE	TITUS	350F	DUCTED RETURN

4-1/4" x 3-5/8"

4-1/4" x 3-5/8"

4.5 1" 4-1/4" x 3-5/8"

1. CONTRACTOR SHALL DETERMINE PROPER MARGIN STYLE TO MATCH CEILING CONSTRUCTION. 2. ALL RUN OUT DUCTWORK TO DIFFUSERS SHALL BE NECK SIZE UNLESS OTHERWISE NOTED.

TRAP S	SCHEDU	JLE							
SYMBOL	SERVICE	TYPE	SAFETY FACTOR	SIZE	LB/HR.	PRESSURE DIFFERENTIAL	MANUFACTURER	MODEL	REMARKS
T-1	DRIP	F&T	10%	3/4"	NOTE 1	10	ARMSTRONG	125A3	NOTES 2, 3, & 4

NOTES:

1. SIZE TRAP FOR EQUIPMENT LOAD. 2. SUITABLE TO 125 PSIG, SIDE INLET & OUTLET, SS FLOAT MECHANISM AND VALVE, CAST IRON BODY, BALANCED PRESSURE

THERMOSTATIC AIR VENT, ALL INTERNALS REPLACEABLE IN-LINE.

3. CAPACITY AT OTHER DIFFERENTIAL PRESSURES SHALL BE AT LEAST 525#/HR AT 10 PSID, AND 1080#/HR AT 75 PSID. 1/8" ORIFICE.

4. WITH INTEGRAL VACUUM BREAKER.

	MECHANICAL MATER	IAL LIST
TAG	DESCRIPTION	ACCEPTABLE MANUFACTURERS
GR-1	GAS PRESSURE REGULATOR - CAST IRON BODY, EXTERNAL PRESSURE RELIEF, THREADED CONNECTIONS, ADJUSTABLE PRESSURE SETTING, TIGHT SHUTOFF. PROVIDE MULTIPLE GAS REGULATORS IF REQUIRED TO MEET OUTLET PRESSURE AND CFH.  5 PSI INLET PRESSURE, 1/2 PSI OUTLET PRESSURE, 4314 CFH CAPACITY, MINIMUM	FISHER, ITRON, SENSUS, MAXITROL OR EQUAL

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SCHEDULE GENERAL NOTES:

MFR = MANUFACTURER

INSTALLED BY:

B. DISCONNECT TYPE:

NF = NON-FUSED

C. CONTROLLER STARTER TYPE:

FV = FULL VOLTAGE

NAME PLATE RATING.

G. CURB TYPE:

A. DISCONNECT AND CONTROLLER STARTER FURNISHED AND

E. NO EQUIPMENT SHALL BE SELECTED ABOVE 90% OF MOTOR

MFR = STANDARD CURB BY MANUFACTURER


F. MUST BE WITHIN +/- 10% OF SCHEDULED RPM.

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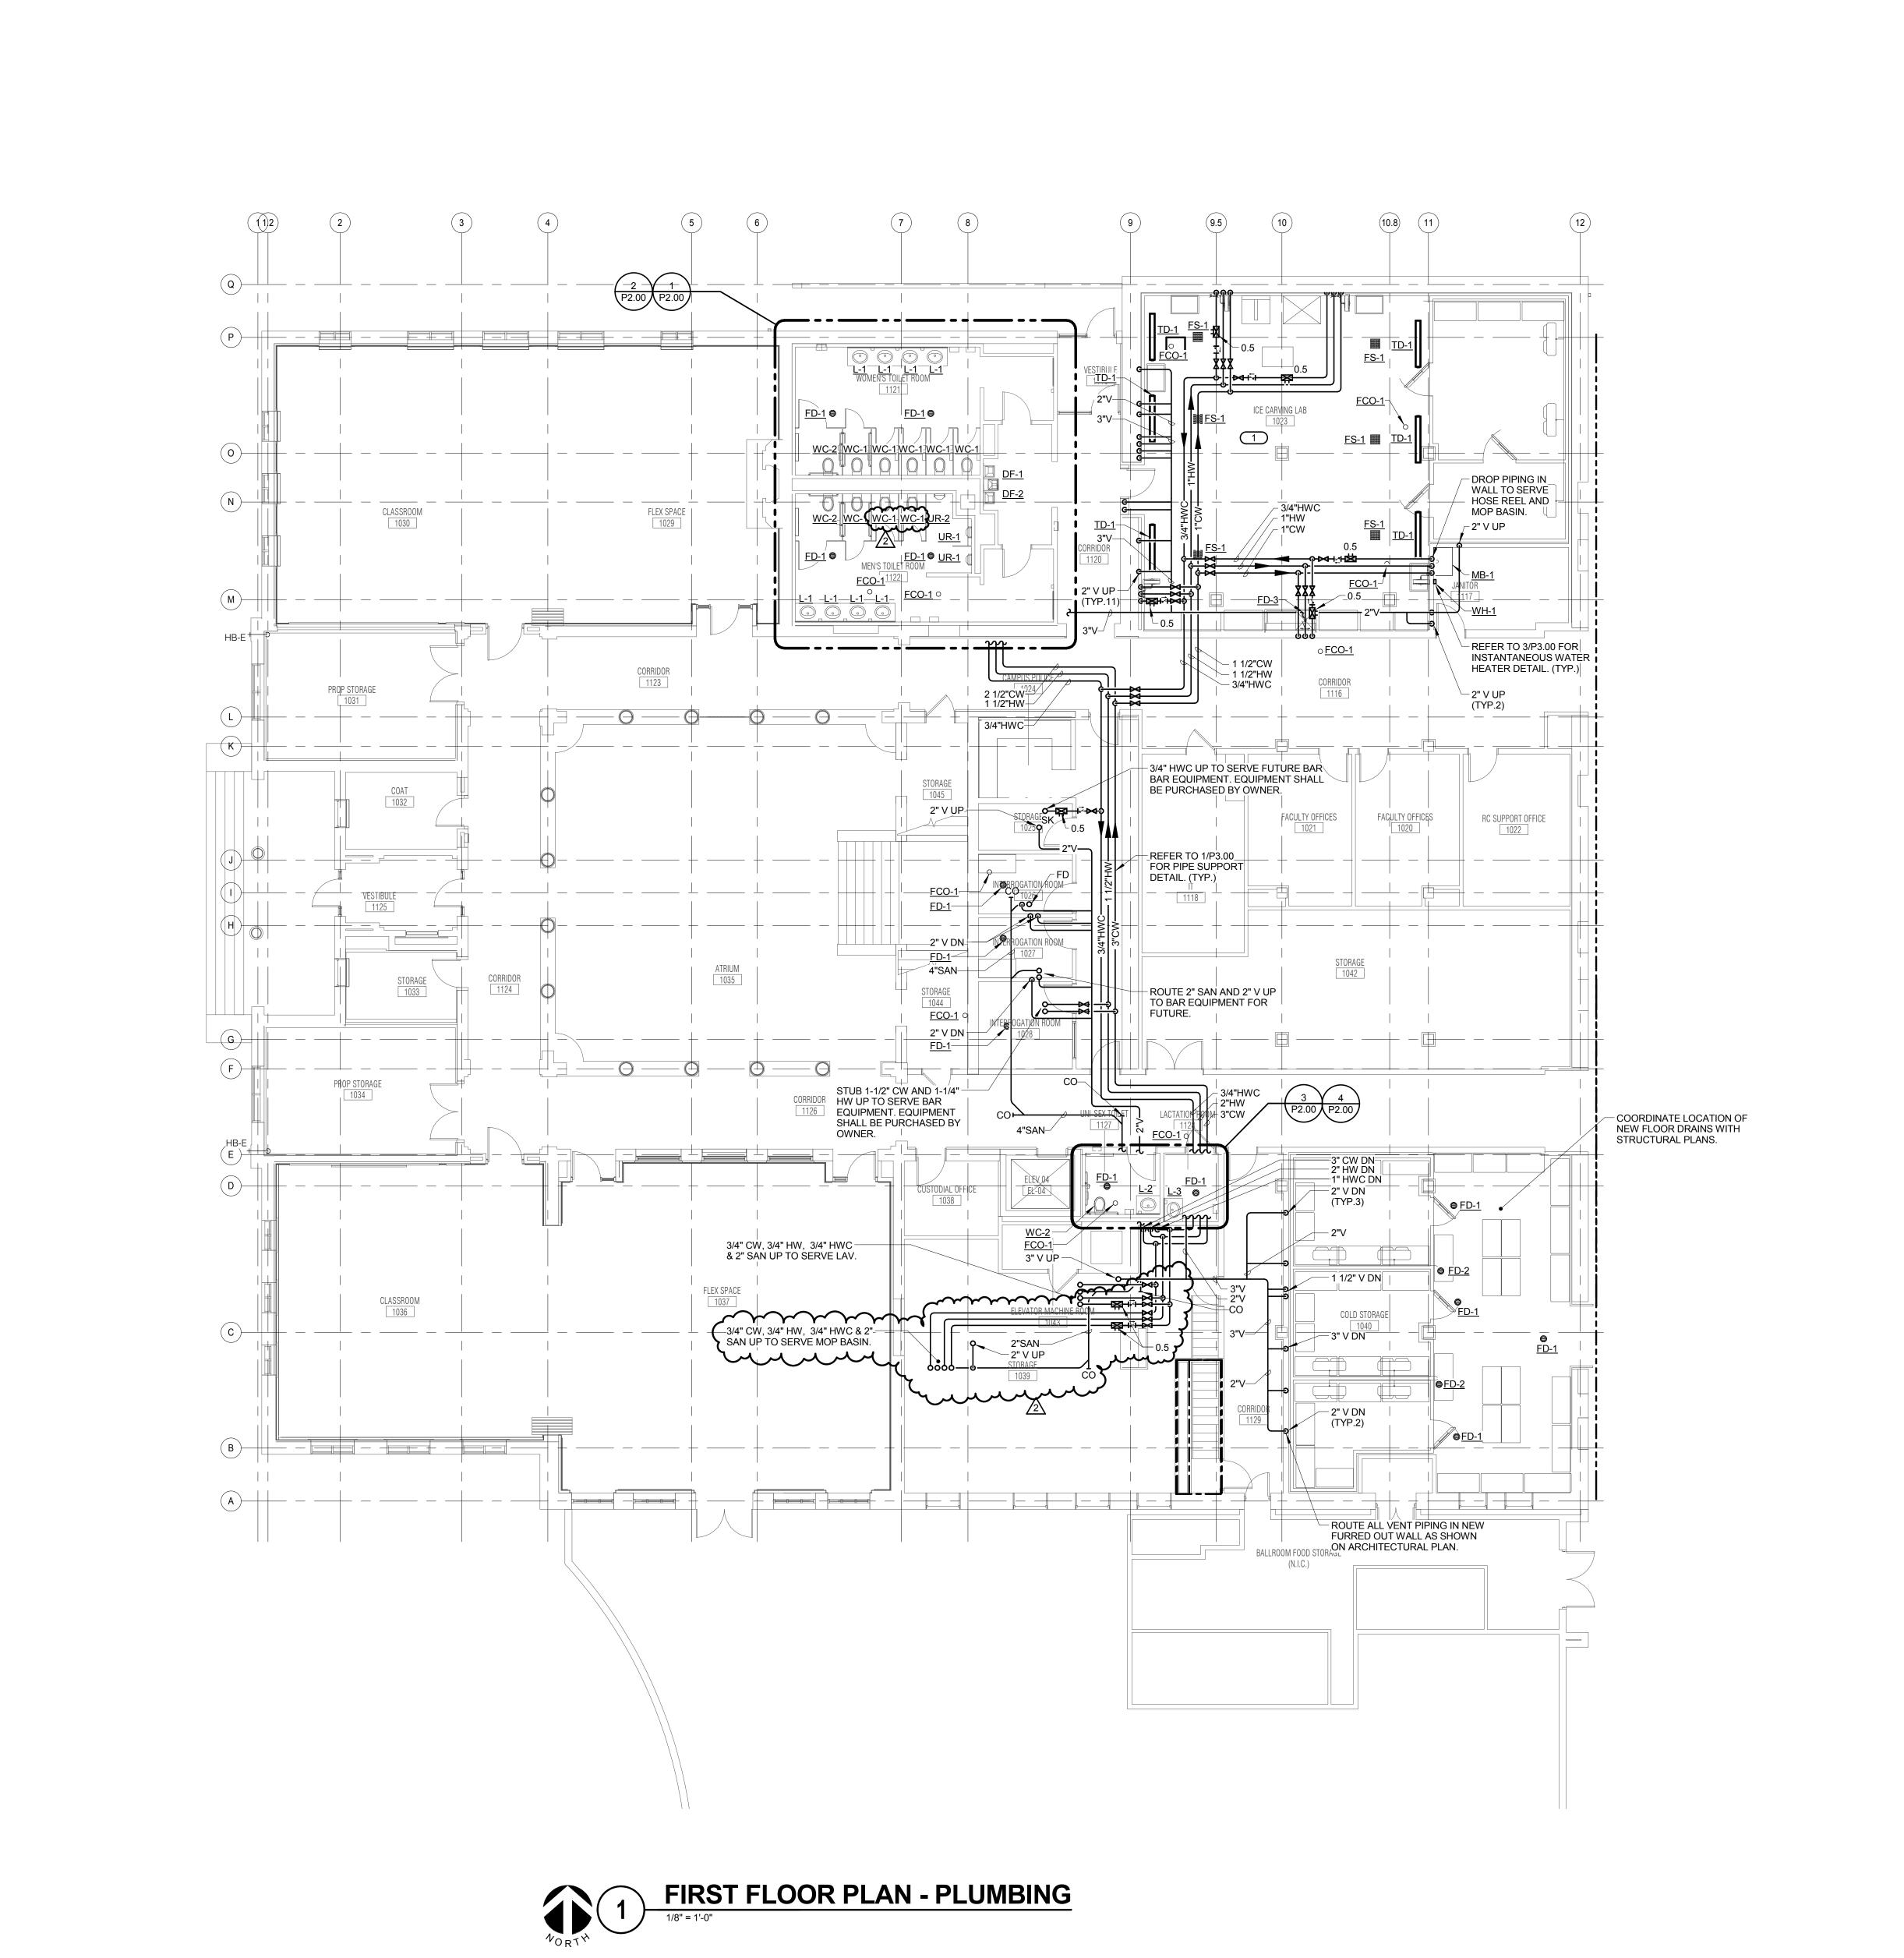
KEY PLAN:

SHEET STATUS: **ISSUED FOR BID** 



SHEET TITLE: **MECHANICAL SCHEDULES AND MATERIAL LIST** 

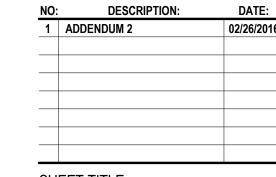SHEET NUMBER:



GENERAL MECHANICAL NOTES
 PROVIDE ACOUSTICAL LAGGING ON ALL PIPING WITHIN THE CEILING SPACE OF THE ICE CARVING LAB. LAGGING SHALL BE CONTINUOUS WITH 2" OVERLAP OF ALL SEAMS AND A 2" OVERLAP AT WALL/CEILING PENETRATIONS. REFER TO SPECIFICATION SECTION 23 07 13 FOR LAGGING REQUIREMENTS.
 ALL DOMESTIC WATER PIPING SHALL BE 3/4" UNLESS NOTED OTHERWISE
 ALL HWC PIPING SERVING FIXTURES SHALL BE ROUTED WITHIN THE WALL AND

KEYNOTES #

1. ROUTE ALL PIPING SERVING PLUMBING FIXTURES WITHIN ICE CARVING IN NEW FURRED OUT WALL AS SHOWN ON ARCHITECTURAL PLANS.

BE CONNECTED WITHIN 3' OF FIXTURE.

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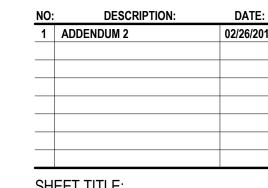
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SUIET JUNIOR COLLEGE
ENAISSANCE CENTER RENOVATION

KEY PLAN:

SHEET STATUS: 02/18/20



SHEET TITLE:
FIRST FLOOR PLAN PLUMBING

SHEET NUMBER:

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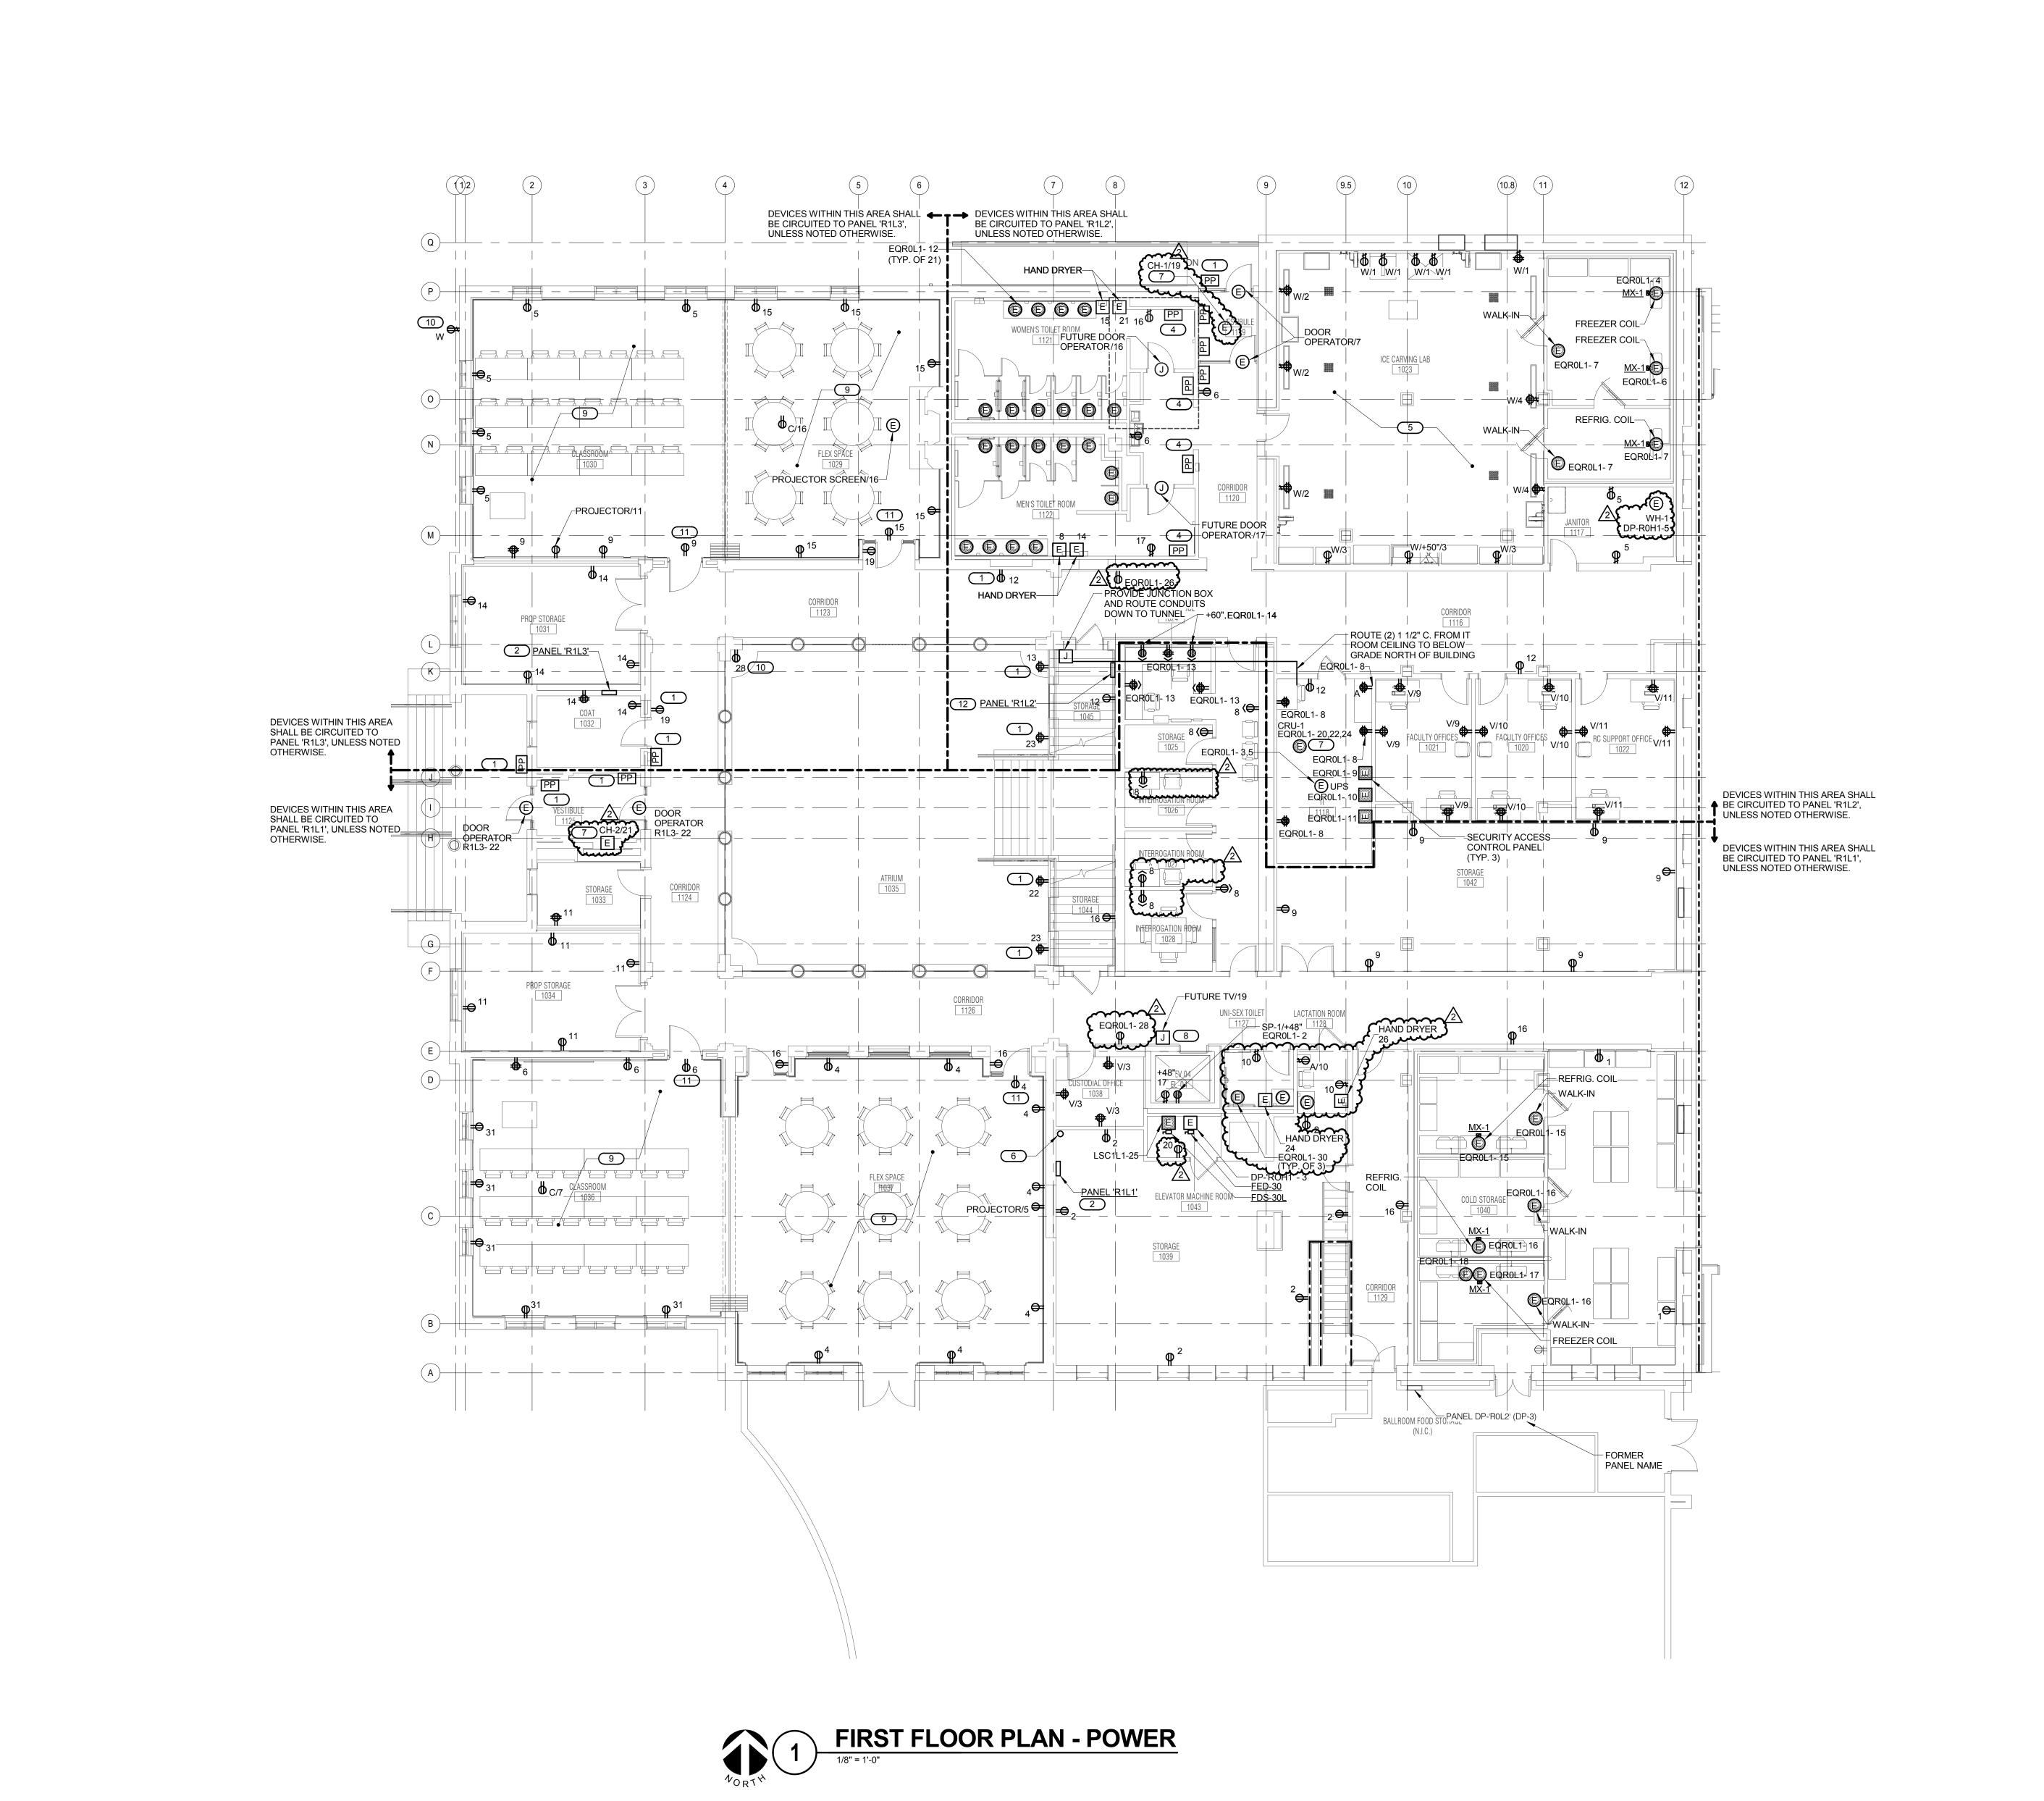
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GENERAL SHEET NOTES

- REFER TO SHEET E0.00 FOR ELECTRICAL GENERAL NOTES, ELECTRICAL INSTALLATION NOTES, AND
- ELECTRICAL SYMBOL LIST.

  REFER TO SHEETS E4.00, E4.01, ED4.00,
- AND ED4.01 FOR ONE LINE DIAGRAMS.
- REFER TO 4/E5.02 FOR SIDE BY SIDE DEVICE OPENING DETAIL.
- REFER TO SHEETS E6.00, E6.01, ED6.00, AND ED6.01 FOR PANEL SCHEDULES.

  EXPOSED CONDUIT SHALL NOT BE
- OTHERWISE.

  6. REFER TO ARCHITECTURAL
  ELEVATIONS FOR ALL DEVICES PRIOR

TO INSTALLATION.

PERMITTED UNLESS NOTED

KEYNOTES #

ROUTE BRANCH CIRCUIT FEEDING DEVICE FROM THE OTHER SIDE OF THE WALL. NO SURFACE MOUNTED CONDUITS SHALL BE VISIBLE IN ATRIUM

- AREA OR ON EXTERIOR WALLS.

  2. RECONNECT EXISTING CIRCUITS FROM DEMOLISHED PANELS. REFER TO PANEL SCHEDULES FOR ADDITIONAL INFORMATION. MATCH CONDUIT AND
- INSTALL IN SURFACE RACEWAY WIREMOD V700 OR EQUAL, PAINTED TO

WIRING. PROVIDE NEW TYPED CIRCUIT

DIRECTORIES (COPY FROM EXISTING).

MATCH WALL.

4. ROUGH-IN ONLY. PROVIDE RECESSED BOX WITH 1/2" C FOR FUTURE PUSHPAD.

STUB TO ABOVE CEILING.

WITH CAULK.

- 5. PROVIDE ACOUSTIC TREATMENT FOR BACKBOXES LOCATED IN EITHER SIDE OF WALLS SURROUNDING ICE CARVING LAB. PENETRATIONS THROUGH THESE WALLS SHALL HAVE A 1/8" GAP SEALED
- 6. ROUTE (2) 1 1/2" C. FROM THIS LOCATION TO BELOW GRADE NORTH OF BUILDING VIA TUNNEL.
- 7. CONNECT TO MANUFACTURER PROVIDED DISCONNECT/CONTROLLER.
- 8. COORDINATE MOUNTING HEIGHT WITH ARCHITECT.9. PROVIDE STAINLESS STEEL
- COVERPLATES FOR DEVICES IN THIS ROOM.
- 10. PROVIDE NEW RECEPTACLE AND COVER IN EXISTING LOCATION.11. PECEPTACLE FOR CLOCK LOCATE
- 11. RECEPTACLE FOR CLOCK LOCATED ABOVE DOOR. COORDINATE EXACT LOCATION WITH A/E.
- 12. PROVIDE EXTENSION ON EXISTING BOX FROM DEMOLISHED PANEL '1-5' TO ALLOW NEW SURFACE CONDUIT TO BE INSTALLED BETWEEN EXISTING BOX AND NEW PANEL. PROVIDE SCREW COVER ON BOX EXTENSION. LOCATE NEW PANEL ADJACENT TO EXISTING BOX.

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ISSANCE CENTER RENOVATION OTTAWA STREET

KEY PLAN:

SHEET STATUS: 02/18/20

NO: DESCRIPTION: DATE

1 ADDENDUM 2 02/26/20

SHEET TITLE:
FIRST FLOOR PLAN POWER

SHEET NUMBER:

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GENERAL TECHNOLOGY NOTES

ALL INFORMATION OUTLETS ON THIS SHEET SHALL BE SERVED FROM HC-1 UNLESS NOTED OTHERWISE.

2. REFER TO ARCHITECTURAL ELEVATIONS FOR MOUNTING HEIGHT AND COORDINATE ALL OUTLET LOCATIONS PRIOR TO ROUGH-IN.

REFER TO T5.00 FOR GENERAL TECHNOLOGY EQUIPMENT SCHEDULE.

KEYNOTES #

COORDINATE WITH ELEVATOR
 CONTRACTOR FOR CONNECTION OF
 ELEVATOR TELEPHONE.

2. ROUGH-IN ONLY FOR FUTURE MONITOR AND EMERGENCY CALL STATION.

3. PROVIDE IN-SERVICE COVERS ON INFORMATION OUTLETS IN THIS ROOM TO MATCH ELECTRICAL. REFER TO DIVISION 27 SPECIFICATIONS FOR ADDITIONAL INFO.

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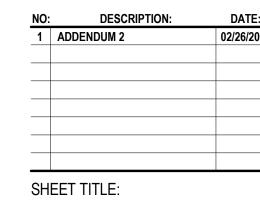
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AISSANCE CENTER RENOVATIO

KEY PLAN:

SHEET STATUS: 02/18/201



FIRST FLOOR PLAN TECHNOLOGY

SHEET NUMBER:

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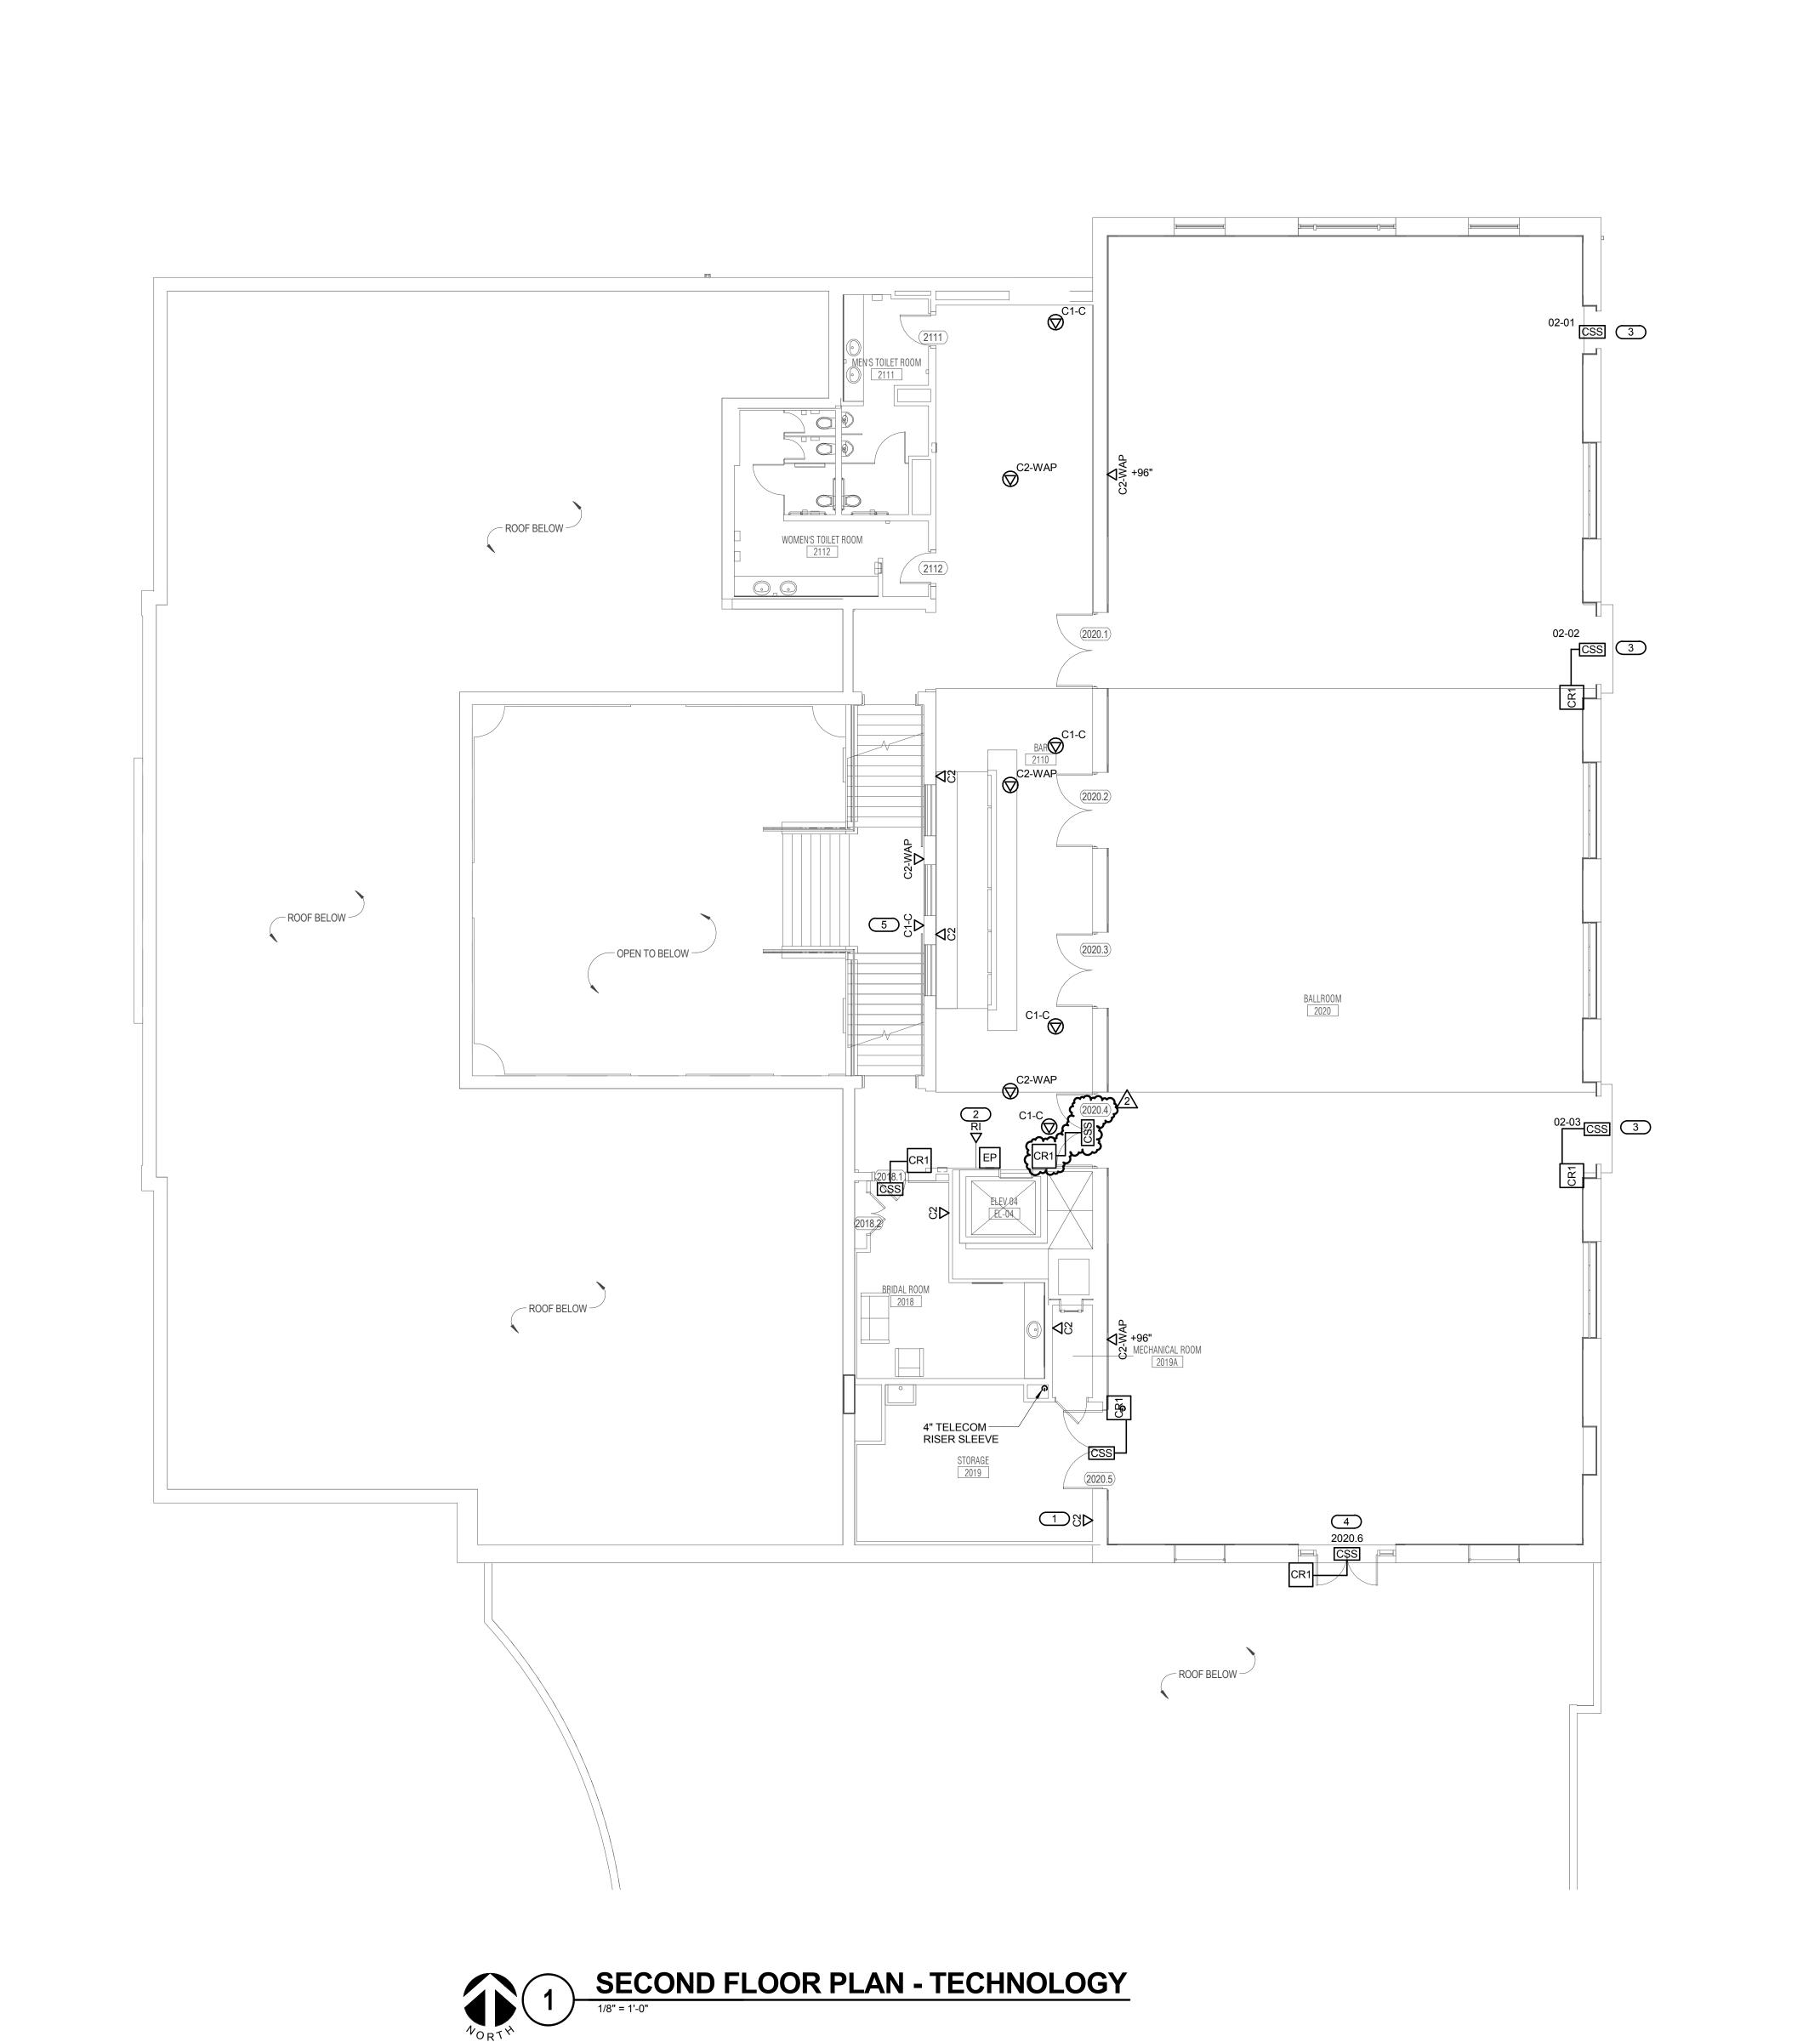
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T1.10

FIRST FLOOR PLAN - TECHNOLOGY

1/8" = 1'-0"



GENERAL TECHNOLOGY NOTES

ALL INFORMATION OUTLETS ON THIS SHEET SHALL BE SERVED FROM HC-1 UNLESS NOTED OTHERWISE. REFER TO T1.10 FOR ROOM LOCATION.

REFER TO T5.00 FOR GENERAL TECHNOLOGY EQUIPMENT SCHEDULE.

KEYNOTES #

COORDINATE LOCATION OF OUTLET

- WITH AUDIO VIDEO RACK. REFER TO ARCHITECTURAL
- ELEVATIONS FOR MOUNTING HEIGHT. CONTRACTOR SHALL ROUTE SECURITY CABLE TO CLOSEST EXISTING CONTROL PANEL IN CITY CENTER BUILDING. COORDINATE ROUTE WITH JJC PRIOR TO INSTALLATION.
- . ROUTE CONDUIT AND CABLE FOR OWNER FURNISHED ACCESS CONTROL SYSTEM DOWN TO CEILING OF FLOOR BELOW. COORDINATE WITH ARCHITECT PRIOR TO INSTALLATION.
- RE-USE EXISTING CAMERA ROUGH-IN LOCATION.

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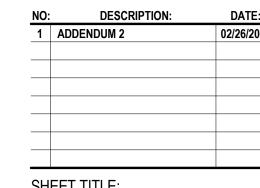
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KEY PLAN:

SHEET STATUS: **ISSUED FOR BID** 



SHEET TITLE: **SECOND FLOOR** PLAN - TECHNOLOGY

SHEET NUMBER:


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DOOR ROUGH-IN AND WIRING DIAGRAM

- INSTALLING CONTRACTOR TO SIZE BACKBOXES AND CONDUIT PER SYSTEM INSTALLATION REQUIREMENTS AND APPLICABLE CODES. MAINTAIN ACCESS TO JUNCTION BOX WHERE CEILING IS A GYPSUM BOARD CEILING. LOCATE BOXES ABOVE NEAREST ACCESSIBLE CEILING AND EXTEND
- CONDUITS TO THIS LOCATION. 2. DETAILS ABOVE MAY NOT BE REPRESENTATIVE OF SPECIFIC DOOR SWING DIRECTION. MIRROR DETAIL
- AS REQUIRED. 3. REFER TO ARCHITECTURAL DOOR HARDWARE GROUPS AND SPECIFICATION FOR COMPLETE
- INFORMATION. 4. PROVIDE DOUBLE GANG BACKBOX WITH SINGLE PLASTER RING AND 1" CONDUIT TO ABOVE ACCESSIBLE SECURE CEILING WHEN IT IS NOT POSSIBLE TO MOUNT CARD READER ON FRAME. 5. REFER TO FLOOR PLANS FOR CARD READER LOCATIONS. REFER TO CONTROLLED SECURITY SCHEME
- TYPE SCHEDULE ON T4.00. KEYNOTES: #
- WHEN REQUIRED BY ARCHITECTURAL DOOR HARDWARE SCHEDULE FOR PROPRITARY POWER SUPPLIES. MOUNT DOUBLE GANG OR LARGER BACKBOXES WITH BLANK COVER PLATES ABOVE
- ACCESSIBLE CEILING. 2. CONTRACTOR SHALL ROUTE MULTI-ELEMENT YELLOW SECURITY CABLE (WINDY CITY PART# 4461030-S OR APPROVED WEST PENN, GRAYBAR EQUAL) FROM EACH DOOR WITH ACCESS CONTROL TO AREA SERVING TELECOM ROOM. COIL 15' AT EACH END AND LABEL.

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ARCHITECT OF RECORD DEMONICA KEMPER ARCHITECTS 125 N. HALSTED STREET, SUITE 301 CHICAGO, IL 60661 P: 312.496.0000

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FOOD SERVICE DESIGN CONSULTANTS **EF WHITNEY** 568 ANN ST.

BIRMINGHAM, MI 48009 T: 248.644.0990

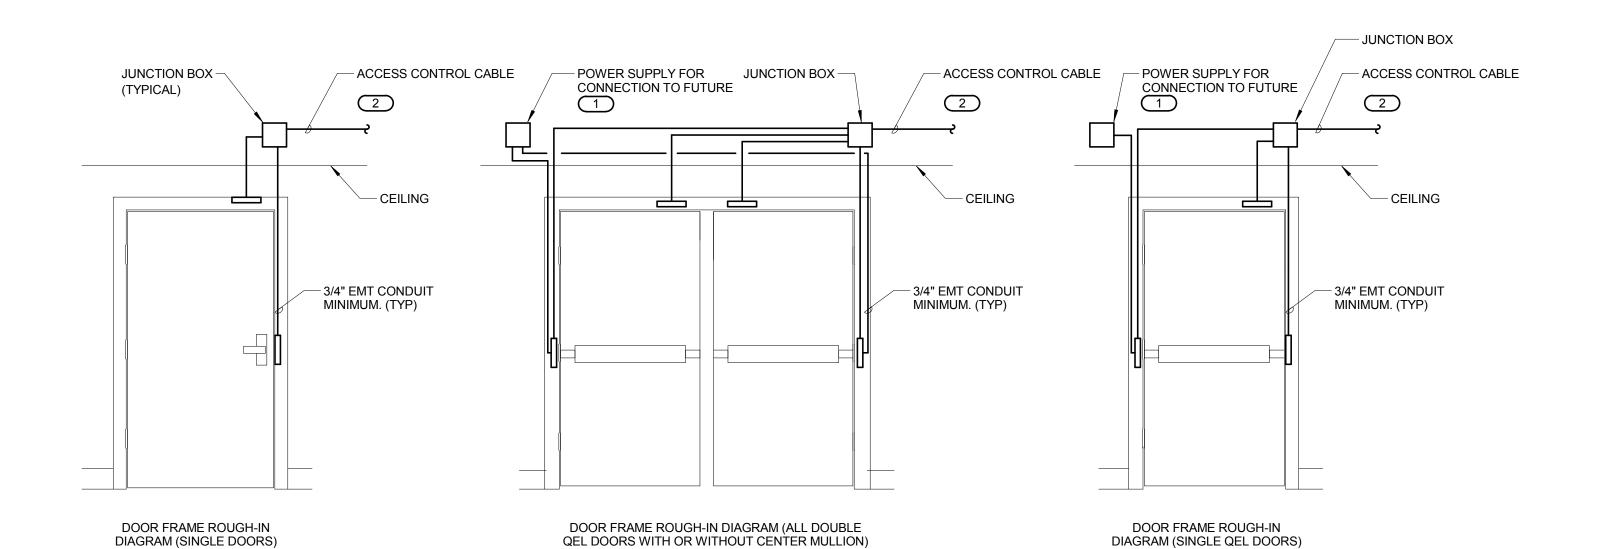KEY PLAN:

SHEET STATUS: **ISSUED FOR BID** 

DESCRIPTION:

SHEET TITLE: **TECHNOLOGY DIAGRAMS AND** 

**SCHEDULES** SHEET NUMBER:

W W ENGINEERING NAPERVILLE ROAD, SUITE 400W NAPERVILLE, ILLINOIS 60563 630.527.2320 FAX: 630.527.2321 www.kjww.com PROJECT # 15.0765.00 Illinois Design Firm Registration #184-000973 KJWW ENGINEERING RESERVES PROPRIETARY RIGHTS, INCLUDING COPYRIGHTS, TO THIS DRAWING AND THE DATA SHOWN THEREON. SAID DRAWING AND/OR DATA ARE THE EXCLUSIVE PROPERTY OF KJWW ENGINEERING AND SHALL NOT BE USED OR REPRODUCED FOR ANY OTHER PROJECT WITHOUT THE EXPRESS WRITTEN APPROVAL AND PARTICIPATION OF KJWW ENGINEERING. © 2016 KJWW, P.C. REFERENCE SCALE IN INCHES
1 2 \_\_\_\_

	GENERAL TECHNOLOGY EQUIPMENT SCHEDULE	
	ABBREVIATIONS AND THE TECHNOLOGY EQUIPMENT SCHEDULE ARE FOR THE CONVENIENCE OF THE CONTRACTOR. EACH VERIFICATION OF QUANTITIES AND SHALL FURNISH ALL MATERIAL REQUIRED, WHETHER SPECIFIED OR NOT, TO PRODUCE A	
RDERED BY MANU	S ARE NOT TO BE CONSIDERED COMPLETE BUT ARE GIVEN ONLY TO AID THE CONTRACTOR IN THE SEARCH FOR MATERIAL. IFACTURER AND CATALOG NUMBER ONLY. EACH CONTRACTOR SHALL FIRST READ THE COMPLETE DESCRIPTION OF THE MA NS. THE FIRST MANUFACTURER LISTED IS THE BASIS OF DESIGN. "STANDARD COLOR" INDICATES FACTORY FINISH AVAILABL	TERIAL ON THESE DRAWINGS
AC-CR1-W	CARD READER ROUGH-IN. FLUSH MOUNT ON WALL OR AS NOTED ON PLANS. ALL SECURITY ROUGH-INS SHALL HAVE (1) 4" SQUARE BACKBOX WITH SINGLE GANG PLASTER RING. APPROPRIATE COVERPLATE, AND (1) 1" EMT CONDUIT TO ABOVE ACCESSIBLE CEILING. HEADEND EQUIPMENT AND CONNECTIONS FOR ACCESS CONTROL SHALL BE LOCATED IN HC-1. CARD READER ROUGH-IN SHALL BE MOUNTED AT 42" A.F.F. REFER TO 1/T4.00 FOR DOOR ROUGH-IN DETAIL FOR MORE INFORMATION.	ROUGH IN ONLY
AC-CSS	ACCESS CONTROL SECURITY SYSTEM ROUGH-IN. REFER TO 1/T4.00 FOR DOOR ROUGH-IN DETAIL FOR MORE INFORMATION.	ROUGH IN ONLY
AC-DC	DOOR POSITION INDICATOR SWITCH, SPDT OR DPDT CONTACTS. 1" DIAMETER OF CONTACTS WITH STANDARD GAP.	GE SECURITY 1076W
		OR APPROVED EQUAL
AC-LD-W	ELECTRIC LOCKING HARDWARE, FURNISHED AND INSTALLED BY DOOR HARDWARE PROVIDER, CONTROLLED BY THE SECURITY SYSTEM. REFER TO ARCHITECTURAL DOOR SCHEDULE FOR ADDITIONAL INFORMATION.  ACCESS CONTROL DOOR LOCKDOWN DEVICE ROUGH-IN. INSTALL (1) 4" SQUARE BACKBOX WITH SINGLE GANG PLASTER RING. APPROPRIATE COVERPLATE, AND (1) 3/4" EMT CONDUIT TO ABOVE ACCESSIBLE CEILING.	* ROUGH IN ONLY
AC-RTE	PIR REQUEST TO EXIT MOTION DETECTOR, DOOR MONITOR WITH SOUNDER ALERT, ADJUSTABLE LATCH TIME, SELECTABLE FAIL SAFE/SECURE, ADJUSTABLE SOUNDER VOLUME, ACTIVATION LED, 12VDC OPERATION, SEQUENTIAL LOGIC INPUT, TWO FORM C CONTACTS. CEILING MOUNTED OR WALL MOUNTED AT 84" AFF.	ROUGH IN ONLY
AV-RI-W	TECHNOLOGY ROUGH-IN, HORIZONTALLY MOUNTED. ALL TECHNOLOGY ROUGH-INS SHALL HAVE (1) 4" SQUARE BACKBOX WITH DOUBLE GANG PLASTER RING UNLESS OTHERWISE NOTED, APPROPRIATE COVERPLATE, 1" EMT CONDUIT AND 3/4" EMT CONDUIT TO ACCESSIBLE CEILING OR AS PER NOTED IN PLANS.	*
IC-EP-W	ROUGH-IN FOR FUTURE EMERGENCY PHONE. PROVIDE (1) 1" EMT CONDUIT TO ABOVE ACCESSIBLE CEILING. COORDINATE MOUNTING HEIGHT WITH ARCHITECT PRIOR TO INSTALLATION.	ROUGH IN ONLY
SC-ER-1	2 POST EQUIPMENT RACK, 42 RU, 79"H x 20.3"W x 3"D STANDARD 19" MOUNTING SPACE, #12-24 THREADED MOUNTING HOLES, DURABLE BLACK POWDER COAT FINISH, MEETS EIA-310-E REQUIREMENTS. 1000 lbs LOAD CAPACITY. UL LISTED.	PANDUIT R2P79
SC-ER-2	4 POST EQUIPMENT RACK, 45 RU, 84"H x 23.25"W x 30" D STANDARD 19" MOUNTING SPACE, #12-24 THREADED MOUNTING HOLES, CURABLE BLACK POWDER COAT FINISH, MEETS EIA-310-E REQUIREMENTS. 2500 lbs LOAD CAPACITY. UL LISTED. PROVIDE WITH PANDUIT PRV8 VERTICAL WIRE MANAGER. PROVIDE WITH (2) RACK MOUNTED, METERED APC PDU'S.	APC AR3100TAA
SC-FDC-1	OPTICAL FIBER DISTRIBUTION CABINET, COMBINATION SHELF, HOLDS UPTO 24 FIBER, SLIDE OUT RAILS TO FACILITATE FRONT ACCESS, JUMPER TROUGHS IN CONNECTOR PANELS TO REDUCE MOUNTING SPACE, PROVIDE WITH CLAMP AND GROUNDING KIT, COUPLING PANELS, LC CONNECTORS, COUPLINGS AND JUMPERS. REQUIRES (4) 1.75" MOUNTING	PANDUIT FRME 4
	SPACES.	COMMSCOPE UNIPRISE TEC
SC-GND-1	WALL-MOUNT GROUND BAR. 4" H X 12" L X 1/4" D COPPER, ELECTRICALLY ISOLATED BY INSULATORS INTEGRAL TO MOUNTING BRACKETS. PROVIDE UNIT CONFIGURED WITH SIXTEEN (16) SETS OF 5/16" HOLES SPACED 5/8" ON CENTER TO	PANDUIT GB4B0612TPI-1
	ACCOMMODATE "A" SPACED TWO-HOLE COMPRESSION LUGS AND THREE (3) SETS OF 7/16" HOLES SPACED 1" ON CENTER TO ACCOMMODATE "C" SPACED TWO-HOLE COMPRESSION LUGS. ANSI/EIA/TIA-607 AND BICSI COMPLIANT. UL LISTED. REFER TO 1/T3.00 FOR ADDITIONAL INFORMATION.	CHATSWORTH PRODUCTS ERICO HARGER
SC-HWM-1	COVER HINGES. INTEGRAL BEND RADIUS CONTROL. PASS THROUGH HOLES ALLOW FRONT TO REAR CABLING. REQUIRES	PANDUIT WMPH2E
	(2) 1.75" MOUNTING SPACES.	COMMSCOPE UNIPRISE
SC-IO-C	INFORMATION OUTLET, CEILING MOUNT, 2, 4 PORT COVERPLATE AS INDICATED ON DRAWINGS, REFER TO INFORMATION OUTLET SCHEDULE ON SHEET T0.00 FOR DETAILS.	COVERPLATE: PANDUIT
	"#" INDICATES INFORMATION OUTLET FACEPLATE CONFIGURATION AS INDICATED ON THE PLANS. REFER INFORMATION OUTLET SCHEDULE ON SHEET T0.00 FOR DETAILS.	CFP2IW  JACK:
	INSTALL INFORMATION OUTLET IN A 4" SQUARE BACKBOX WITH A SINGLE GANG PLASTER RING. INSTALL A 1" EMT	PANDUIT (CAT6)
SC-IO-W	CONDUIT TO ABOVE ACCESSIBLE CEILING. PROVIDE REMOVABLE BLANK INSERTS FOR UNUSED PORTS (PANDUIT CMB).  INFORMATION OUTLET, WALL MOUNT, 2, 4, 6-PORT COVERPLATE AS INDICATED ON DRAWINGS, REFER TO INFORMATION	CJ688TGIW COVERPLATE:
	OUTLET SCHEDULE ON SHEET TO.00 FOR DETAILS.	PANDUIT CFP2IW
	"#" INDICATES INFORMATION OUTLET FACEPLATE CONFIGURATION AS INDICATED ON THE PLANS. REFER INFORMATION OUTLET SCHEDULE ON SHEET T0.00 FOR DETAILS.	CFP4IW CFPE6IWY
	INSTALL INFORMATION OUTLET IN A 4" SQUARE BACKBOX WITH A SINGLE GANG PLASTER RING. INSTALL A 1" EMT CONDUIT TO ABOVE ACCESSIBLE CEILING. PROVIDE REMOVABLE BLANK INSERTS FOR UNUSED PORTS (PANDUIT CMB).	JACK: PANDUIT (CAT6) CJ688TGIW
SC-LR-1	LADDER RACK, 18" W TUBULAR STEEL CONSTRUCTION, RUST RESISTANT ENAMEL FINISH, REMOVE SHARP BURRS FROM LADDER RACK AND REPAINT ALL AREAS THAT HAVE BEEN FIELD MODIFIED, CUT OR EXPOSED. U.L. LISTED.	HOMACO INC. TR10-18
		CHATSWORTH PRODUCTS
SC-MPP-1		B-LINE PANDUIT
	PORT IDENTIFICATION NUMBERS, PROVIDED WITH COLOR CODING AND LABEL HOLDER KITS, U.L. LISTED. REQUIRES (2) 1.75" MOUNTING SPACES.	CAT 6: DP48688TGY
		COMMSCOPE UNIPRISE TEC
SC-RI-W	TECHNOLOGY ROUGH-IN, HORIZONTALLY MOUNTED. ALL TECHNOLOGY ROUGH-INS SHALL HAVE (1) 4" SQUARE BACKBOX WITH SINGLE GANG PLASTER RING UNLESS OTHERWISE NOTED, APPROPRIATE COVERPLATE AND 3/4" EMT CONDUIT TO ACCESSIBLE CEILING OR AS PER NOTED IN PLANS.	*
SC-TTB	TELECOMMUNICATIONS TERMINAL BOARD, 4' X 8' X 3/4" A-C GRADE FIRE-RATED PLYWOOD. EXPOSED SIDE SHALL BE SMOOTH. MOUNT VERTICALLY WITH TOP OF PLYWOOD AT 8'6" A.F.F	*
SC-VWM-1	VERTICAL WIRE MANAGER, 83"H X 4.9"W X 12"D. INCLUDES HINGED COVERS, CABLE RETAINERS, MOUNTING BRACKETS AND #12-24 SCREWS. BLACK POWDER COATED.	PANDUIT WMPV45E
SC-WP-W	INFORMATION OUTLET, WALL PHONE. PROVIDE (1) RJ-45 JACK FOR VOICE AT +48" AFF FOR WALL HUNG PHONE. PROVIDE WITH STAINLESS STEEL FACEPLATE, MATING LUGS.	COVERPLATE: PANDUIT
	INSTALL INFORMATION OUTLET IN A 4" SQUARE BACKBOX WITH A SINGLE GANG PLASTER RING. INSTALL A 3/4" EMT	KWP6PY
	CONDUIT TO NEAREST ACCESSIBLE CEILING.	JACK: PANDUIT CAT 6
		CJ688TGIW
		NO SUBSTITUTION

INFORMATION OUTLET SCHEDULE											
SINGLE GANG WALLPLATE	<u>s</u>										
	2-Port F	aceplate	_	4-P	ort Facepla	ite		6-Port Faceplate			
		FICATION 1			1 2			IDENTIFICATION  1 2		PAIR 3 PAIR 2 PAIR 1 PAIR 4	
		2			3 4			3     4       5     6		1 2 3 4 5 6 7 8 WO O WG BL WBL G WBRBR	
NUMBER INDICATES — FACEPLATE POSITION	IDENTI	FICATION			IDENTIFICATION			IDENTIFICATION			
(TYP.)			_					O SPECIFICATIONS FOR CATION REQUIREMENTS (TYP.)		ANSI/TIA/EIA T568B PIN/PAIR ASSIGNMENT	
NOTES:										LEGEND	
PROVIDE REMOVABLE B	BLANK INS	ERT(S) FO	R ALL UN	USED PO	RTS.				DATA	CAT 6 RJ-45	
2. REFER TO SPECIFICAITONS SECTION 27 05 53 FOR ADDITIONAL INFORMATION ON LABELING REQUIREMENTS.									BLANK	BLANK FILLER MODULE	
SCHEDULE NOTES:											
1. LOCATION OF FUTURE OR OWNER PROVIDED WIRELESS ACCESS POINT. PROVIDE A 20' SLACK COIL AT THE NEAREST CABLE											
SUPPORT FOR POSSIBLE RELOCATION AFTER WIRELESS SURVEY.  2. CONTRACTOR SHALL TERMINATE CABLES ON 8P8C RJ-45 PLUG FOR DIRECT CONNECTION TO FUTURE CCTV CAMERA. PROVIDE											
20' SLACK AT NEAREST (	CABLE SU	JPPORT FO					₹.				
	FACEPLATE PORT IDENTIFICATION										
	E PORTS	JACK TYPE	JACK TYPE	JACK TYPE	JACK TYPE	JACK TYPE	JACK TYPE				
	F	ž	7	က	4	2	9				
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0011510115151011	FACEPLA	POSITION	POSITION	POSITION	POSITION	POSITION	POSITION		0750		
CONFIGURATION C1	2	DATA	BL	<u> </u>	<u> </u>	<u> </u>	<u> </u>	N	OTES		
C1-C	0	DATA	DL					2.			
C2	2	DATA	DATA					<del></del> -			
C2-WAP		DATA	DATA					1.			
C3	4	DATA	DATA	DATA	BL						
C6	6	DATA	DATA	DATA	DATA	DATA	DATA				




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FOOD SERVICE DESIGN CONSULTANTS **EF WHITNEY** 568 ANN ST. **BIRMINGHAM, MI 48009** T: 248.644.0990

KEY PLAN:

SHEET STATUS: **ISSUED FOR BID** 

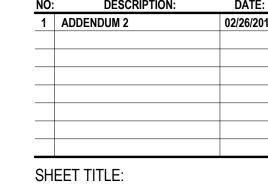

TECHNOLOGY MATERIAL LIST

SHEET NUMBER:

ENGINEERING
GONSULTANTS
The FUTURE.
Built SMARTER.\*


I100 WARRENVILLE ROAD, SUITE 400W
NAPERVILLE, ILLINOIS 60563
630.527.2320 FAX: 630.527.2321
www.kjww.com
PROJECT # 15.0765.00


Illinois Design Firm Registration #184-000973


Illinois Design Firm Registration #184-000973


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STRUCTURAL & MEP/FP ENGINEERS

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BIRMINGHAM, MI 48009
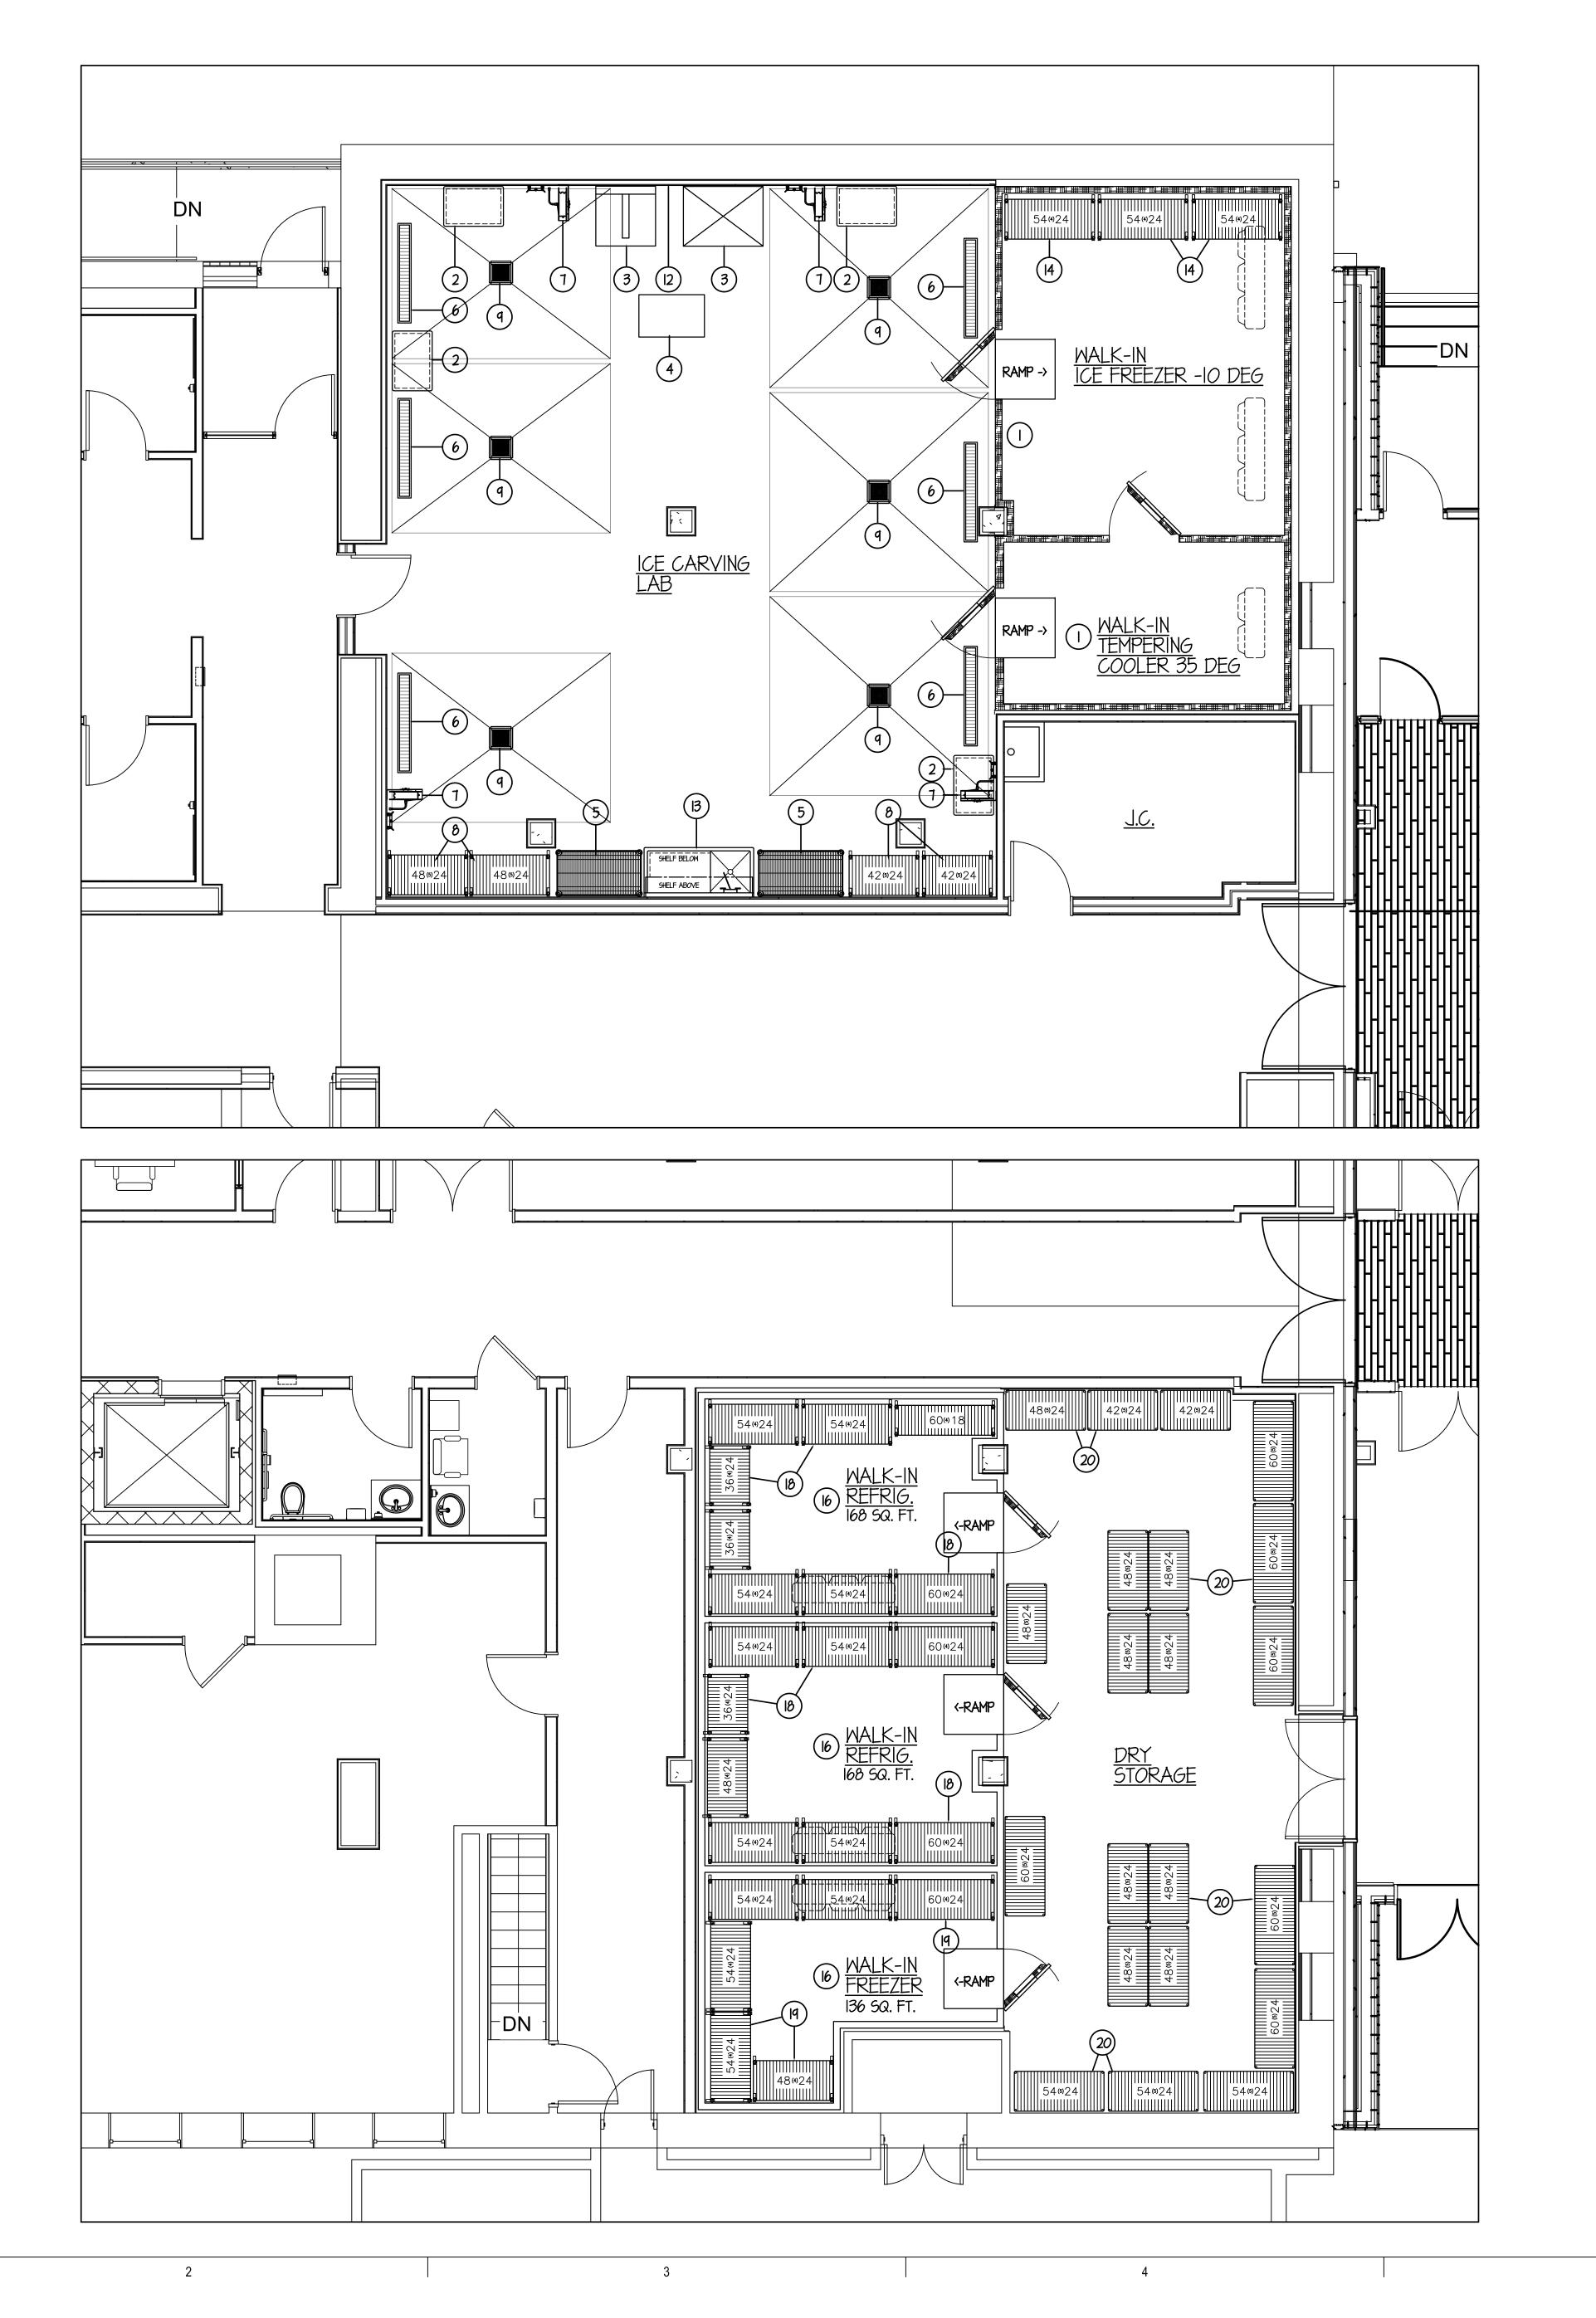
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## JOLIET JUNIOR COLLEGE RENAISSANCE CENTER RENOVATIO

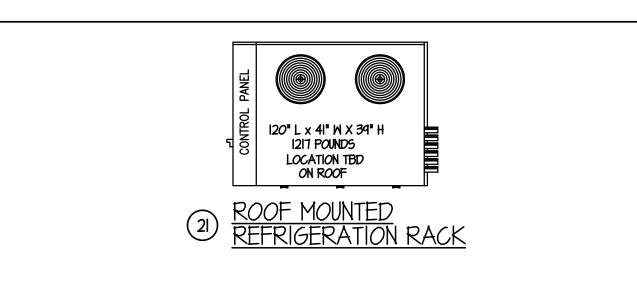
KEY PLAN:

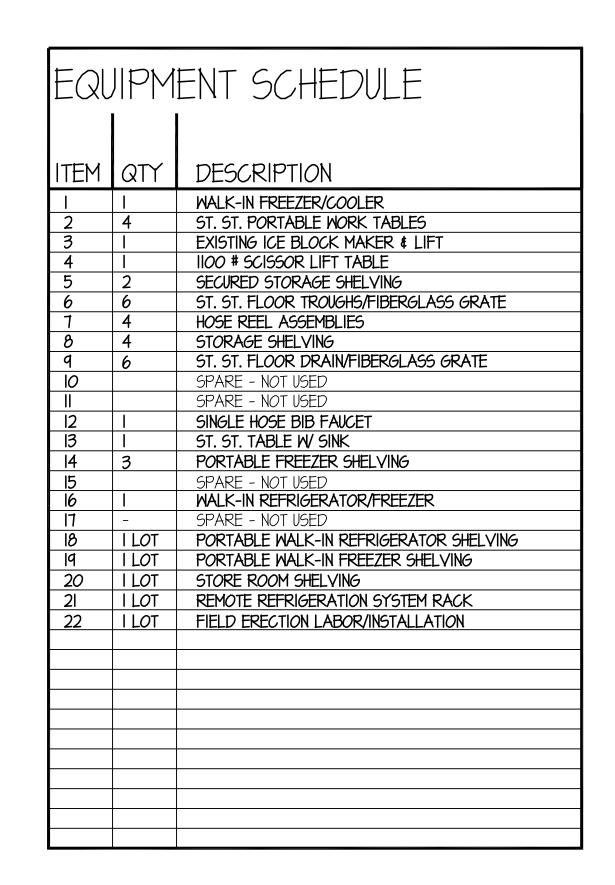SHEET STATUS: 02/18/

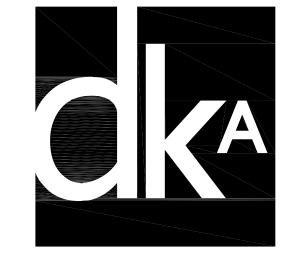NO: DESCRIPTION: DATE:

EQUIPMENT LAYOUT & SCHEDULE

SHEET NUMBER:

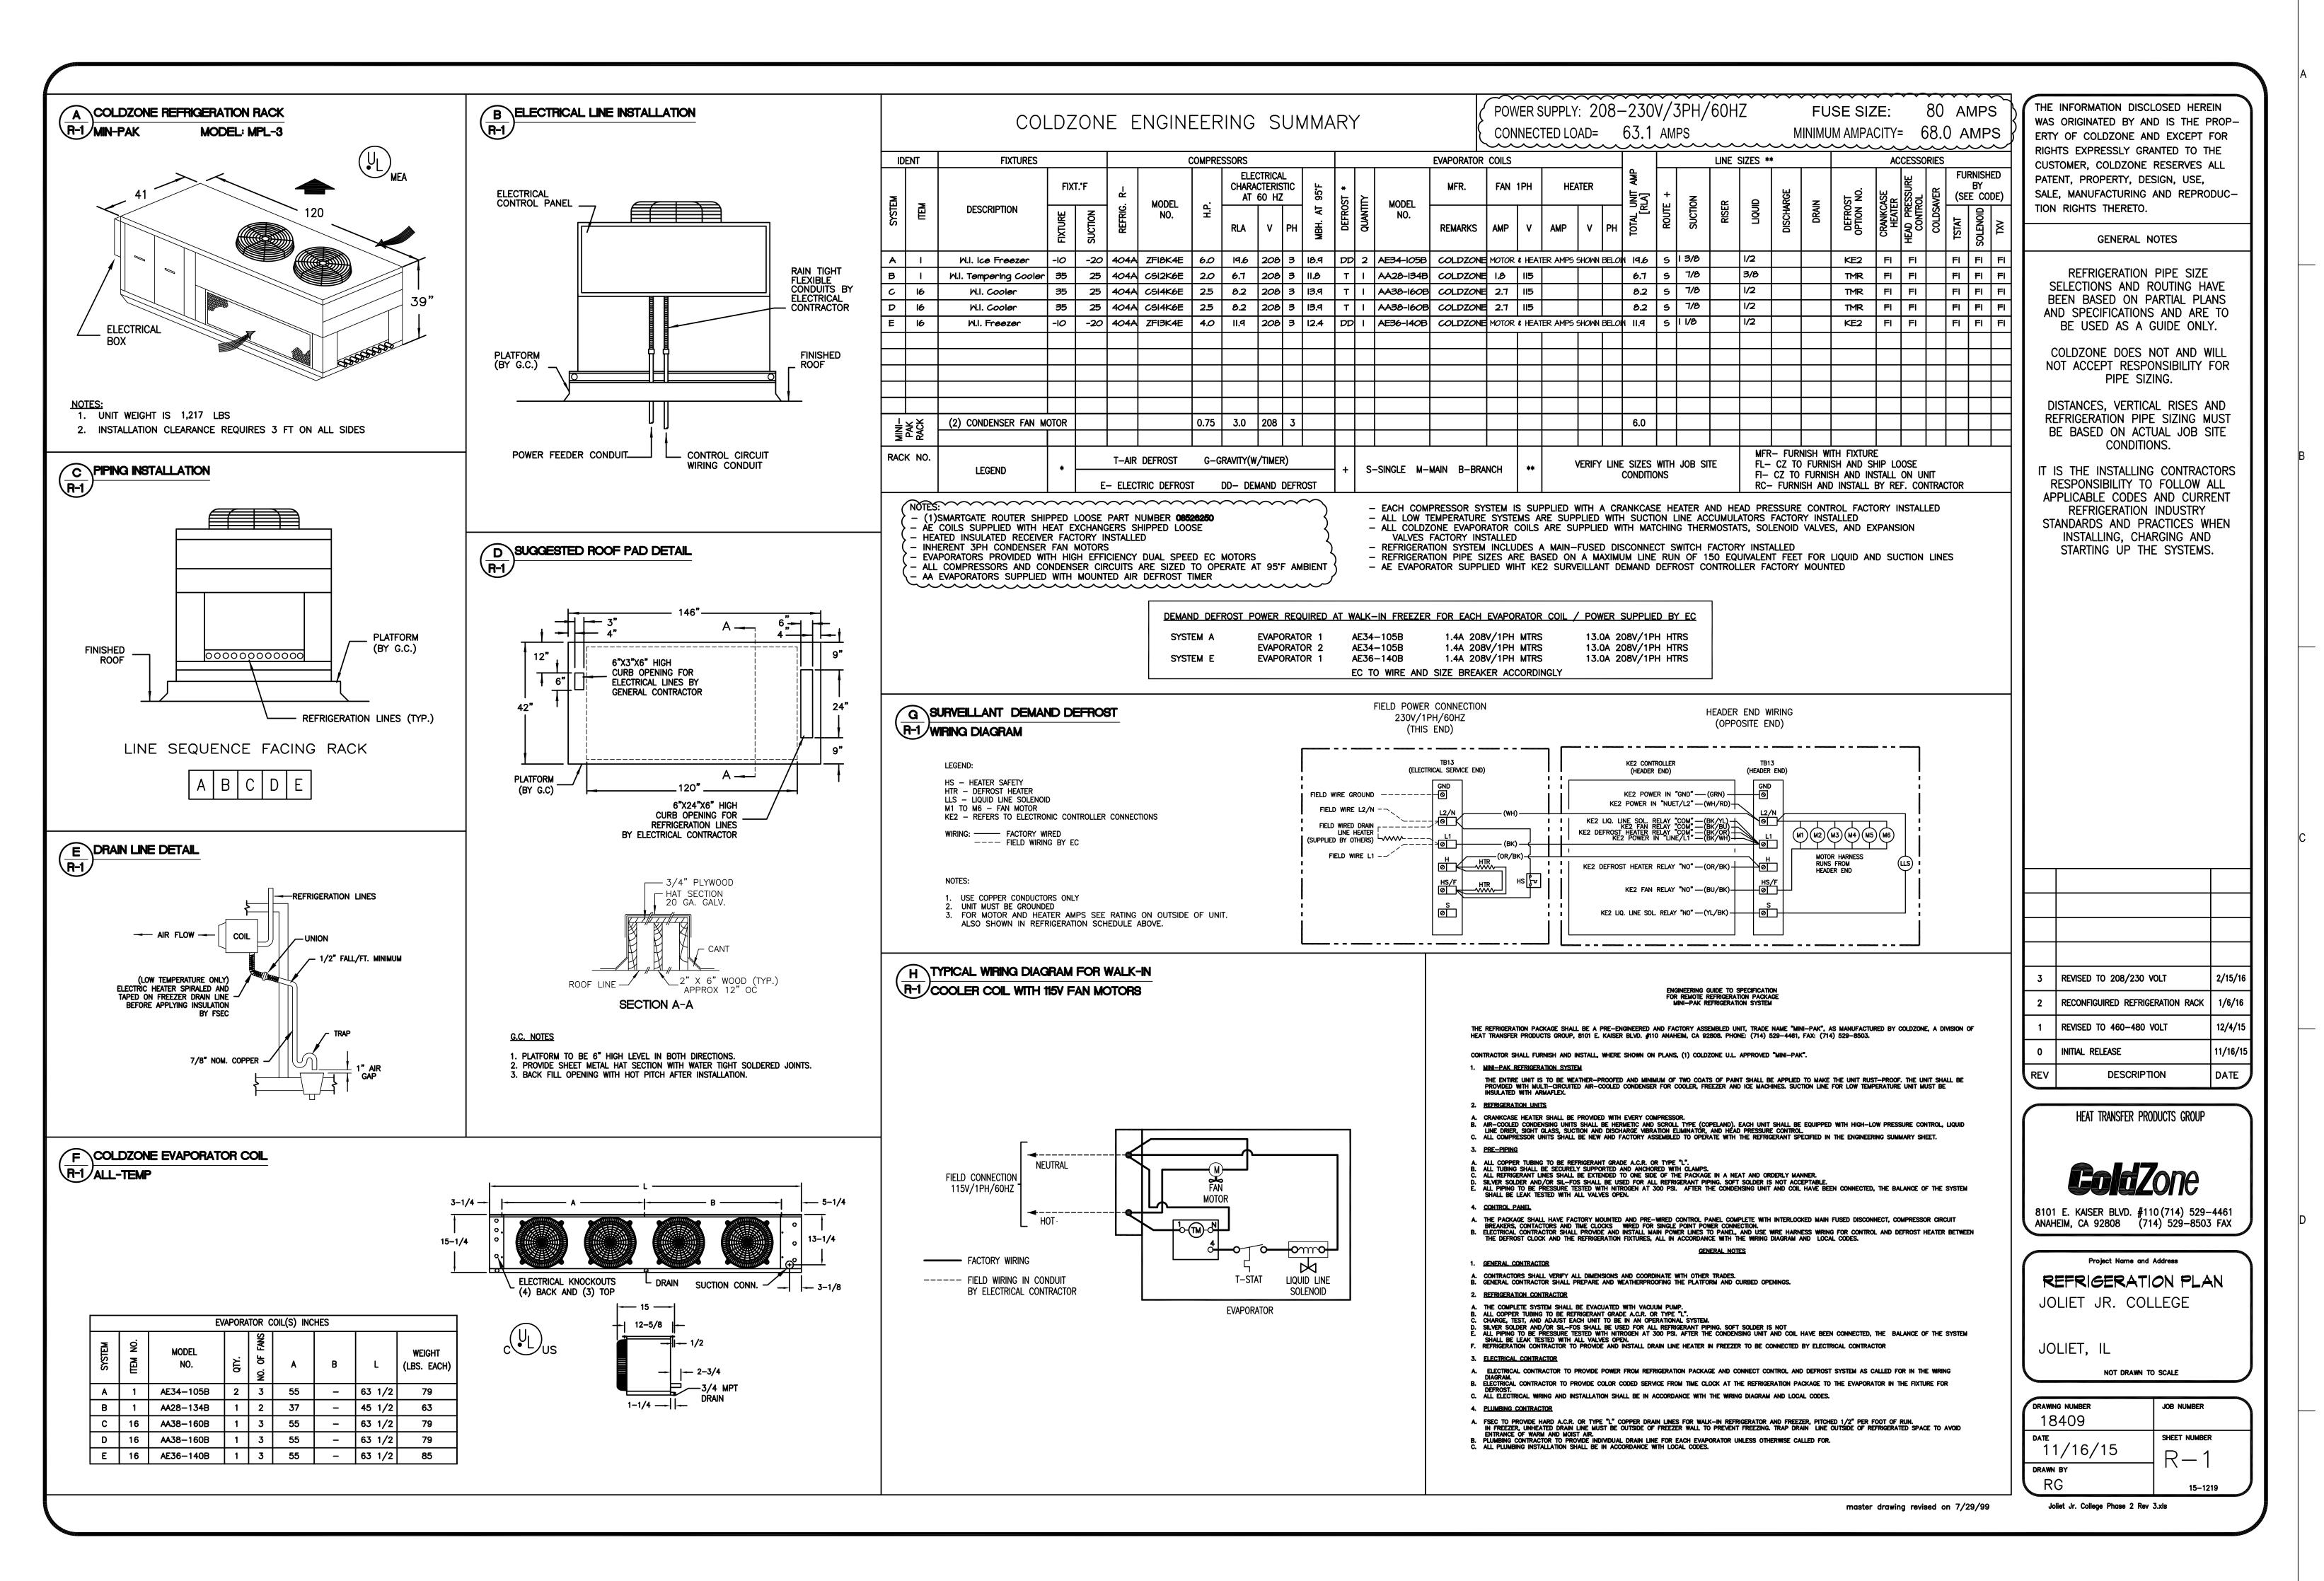

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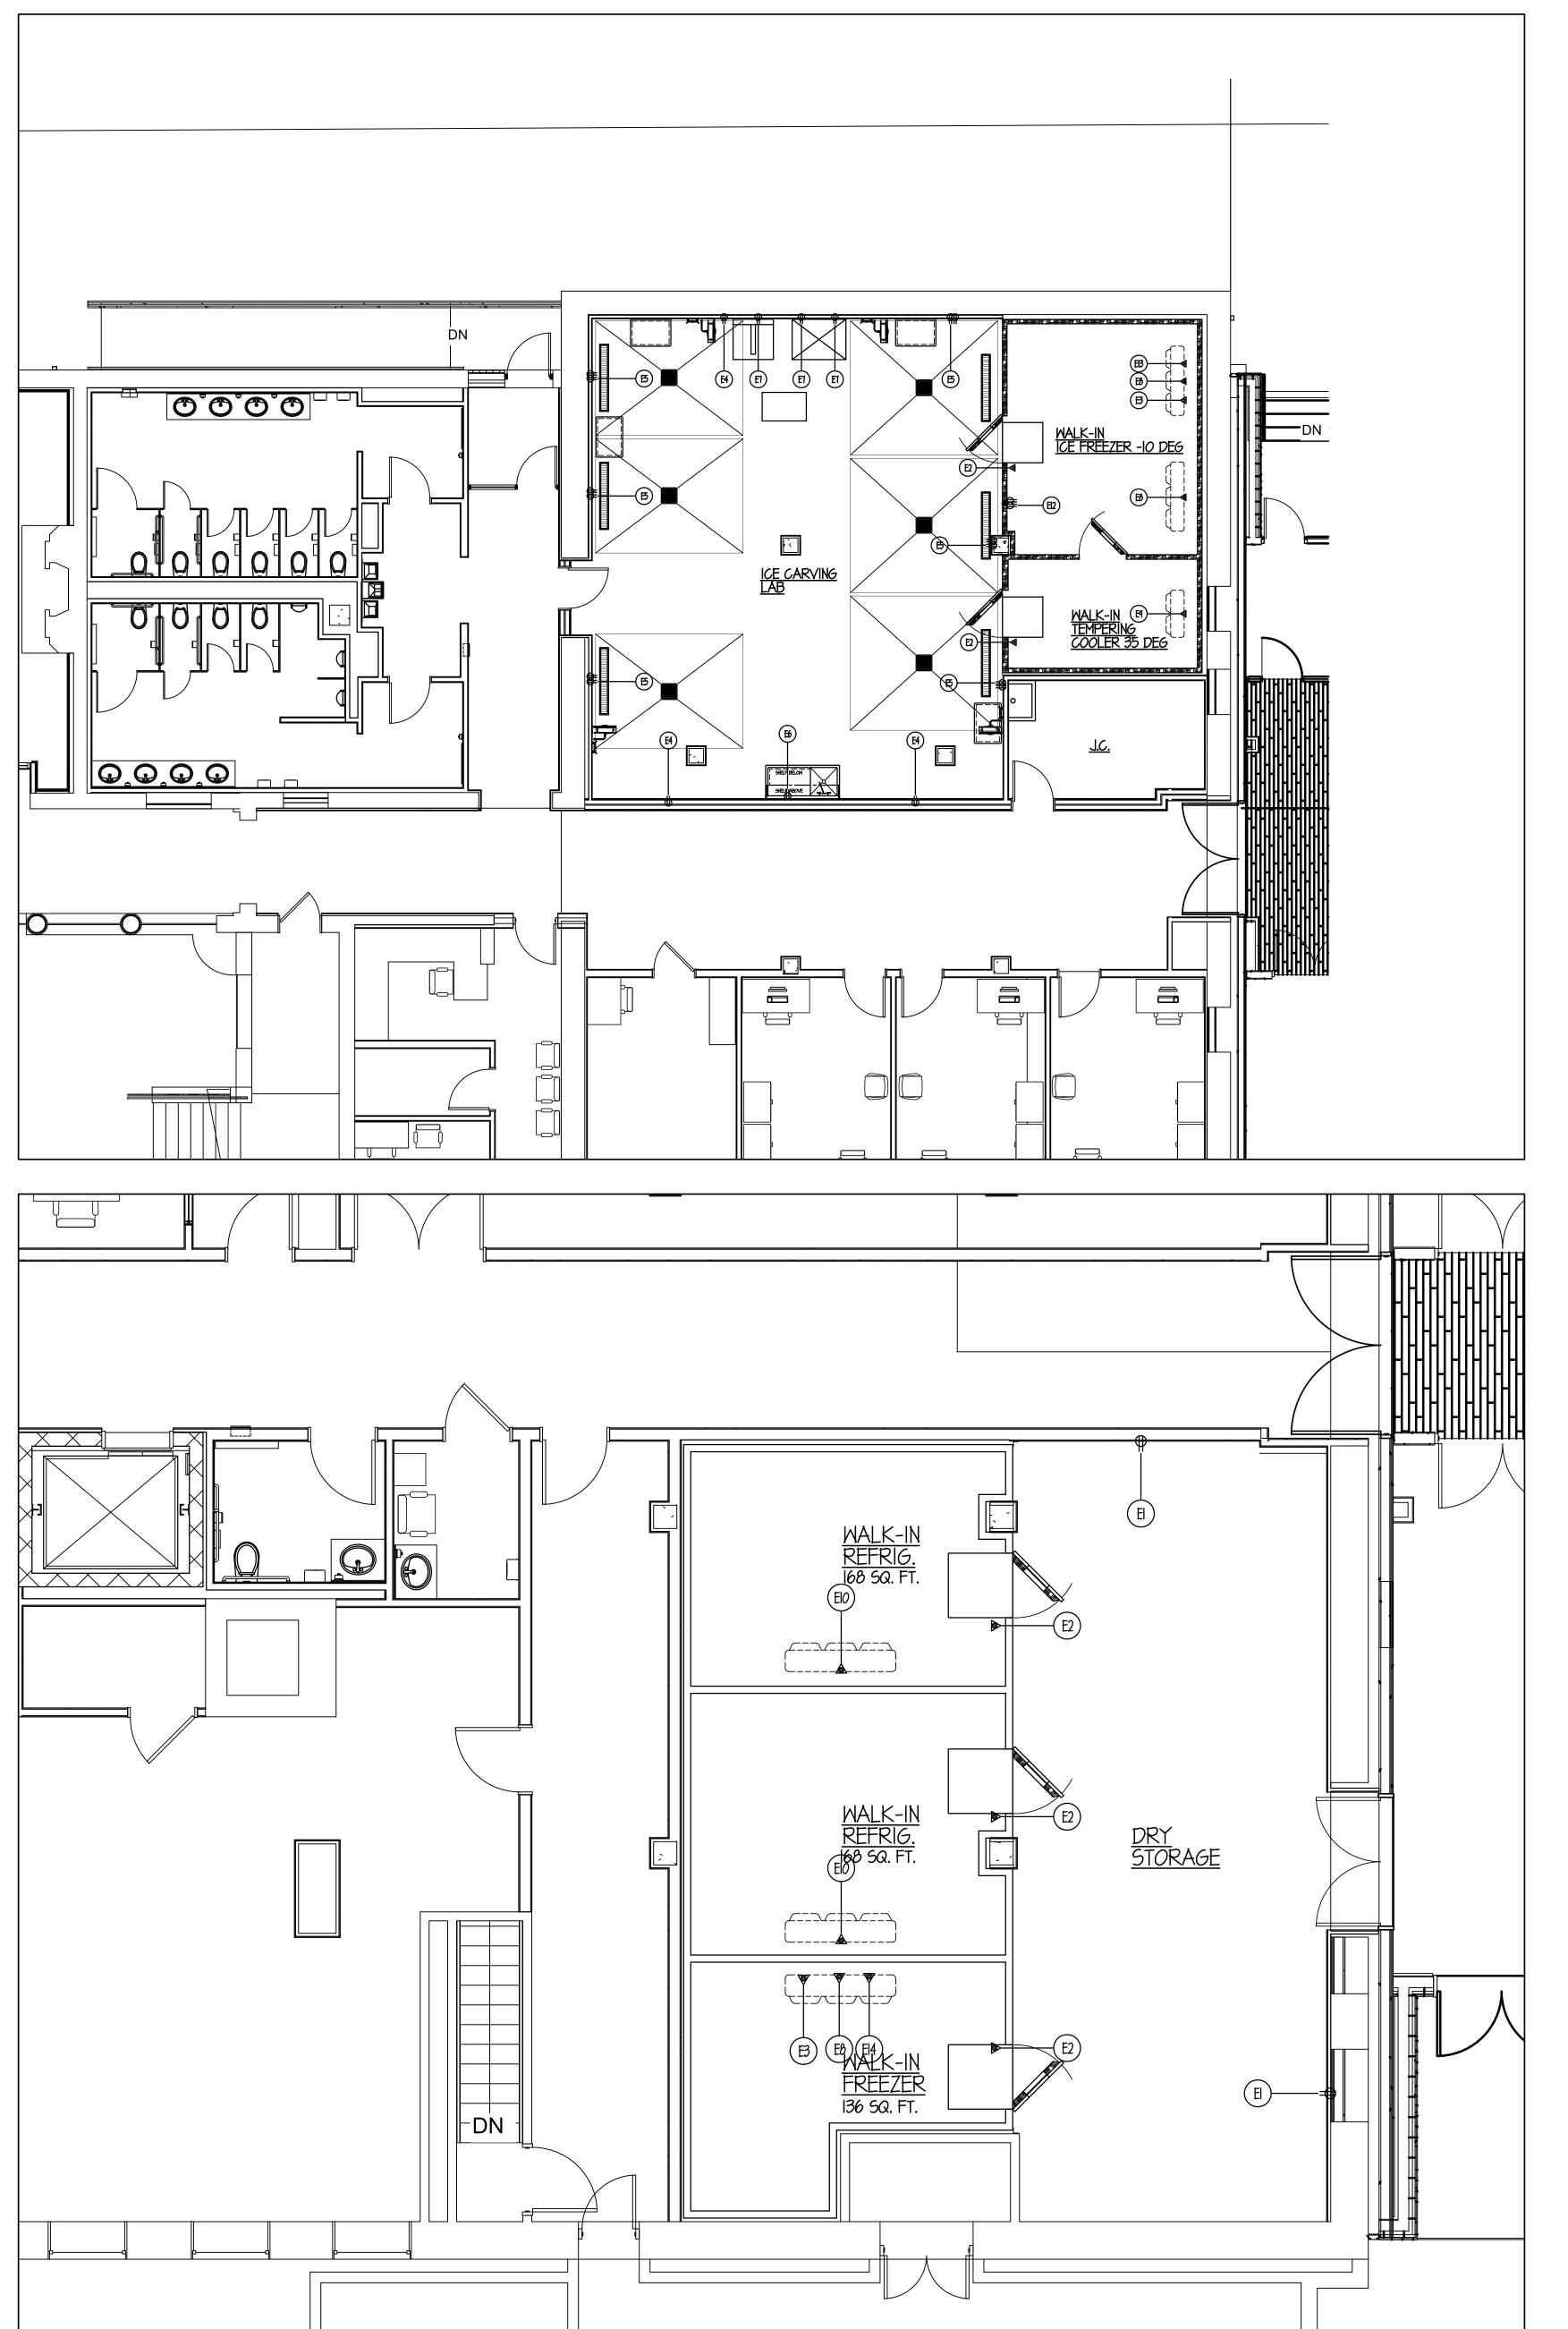
KEY PLAN:

SHEET STATUS: **ISSUED FOR BID** 

DESCRIPTION: SHEET TITLE:

**ROOF MOUNTED REFRIGERATION RACK DETAILS** 

SHEET NUMBER:



GENERAL NOTES FOR ROUGH-IN PLAN

THIS PLAN IS TO BE USED FOR BIDDING PURPOSES ONLY & MUST BE REDRAWN BY FOOD SERVICE

EQUIP. CONTR. USING ARCHITECTS
FINAL WORKING DRAWINGS (ARCH.,
ELECT., PLUMB. & VENT.). F.S.EQ.
CONTR. SHALL FURNISH FULLY

DIMENSIONED ROUGH-IN PLAN FOR ELECTRICAL, PLUMBING, VENTILATION, DEPRESSION & WALL OPENINGS WITHIN 30 DAYS AFTER AWARD OF CONTRACT. PLANS ARE TO BE REDRAWN & NOT TRACED-OFF OF

FOOD SERVICE EQUIP. CONTR. IS TO ASSIST ELECTRICAL TRADES DURING PERIOD WHILE FINAL ROUGH-N CONNECTIONS ARE BEING MADE. F.S.EQ. CONTR. SHALL FURNISH ALL NECESSARY WIRING DETAILS AS REQUIRED. F.S.EQ. CONTR. ALSO TO HAVE FIELD SUPERVISOR ON JOBSITE AT TIME OF FINAL CONN'S. FOOD SERVICE EQUIP. CONTR. SHALL CONTACT ELECTRICAL

ENGINEER BEFORE DRAWING ROUGH-PLAN TO VERIFY EXACT VOLTAGES AVAILABLE ON JOBSITE. THIS CHECK MUST BE MADE TO INSURE PROPER

ELECTRICAL ROUGH-IN CODE

JUNCTION BOX ELECTRICAL CONDUIT CONNECTION HORSEPONER

KILOWATT

SINGLE PHASE

DUPLEX RECEPTACLE SINGLE RECEPTACLE DUPLEX FLOOR RECEPTACLE SINGLE FLOOR RECEPTACLE FUSED DISCONNECT SWITCH SMITCH ABOVE FINISH FLOOR

GENERAL NOTE for ROUGH-IN PLAN

<u>↑ 🗖 🔻 ♦ ♦ </u> †


ALL SERVICES SHOWN WITH SYMBOLS CENTERED ON WALL SHOULD BE BROUGHT TO THAT POINT CONCEALED

IN WALL & STUBBED-OUT AT HEIGHT SHOWN ON THIS PLAN OR F.S.EQ. CONTR'S FINAL DIMENSIONED ROUGH-IN PLAN. <u>DO NOT</u> STUB OUT OF FLOOR & RUN EXPOSED ON WALL.

ALL MALK-INS:
DRAIN LINE BY FEEC FROM COIL TO IM.
MALK-IN FREEZERS ONLY:
FEEC TO HEAT TAPE ALL
DRAIN LINES THRU MALK-IN FREEZERS.

<u>DRAIN LINE DETAIL for</u> MALK-IN REFRIG/FREEZER

ORIGINAL DRAWINGS.

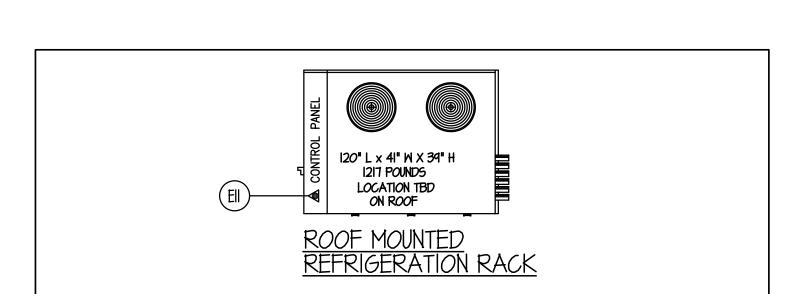

### ELECTRICAL NOTES

- (EI) 120V-1ph. DUPLEX RECEPTACLE FLUSH IN WALL 18" A.F.F. FOR GENERAL USE.
- E2) 20 AMP (CIRCUIT) 120V-1ph. COND. CONN. DROP-DOWN FROM ABOVE FOR WALK-IN. ALL LIGHTS & DOOR HEATER SERVICES PRE-WIRED BY F.S.EQ. CONTR. TO J.B. ON TOP W/ FINAL CONN. BY ELECT. TRADES.
- (E3) 500 WATT 120V-1ph. COND. CONN. DROP-DOWN FROM ABOVE FOR HEAT TAPE.
- (E4) 120V-1ph. WATER-PROOF DUPLEX RECEPTACLE FLUSH IN WALL 18" A.F.F. FOR GENERAL USE.
- (E5) 20 AMP (CIRCUIT) 120V-1ph. WATER-PROOF QUAD RECEPTACLE FLUSH IN WALL 18" A.F.F. FOR CHAIN SAW USE.
- (E6) 20 AMP (CIRCUIT) 120V-1ph. WATER-PROOF DUPLEX RECEPTACLE FLUSH IN WALL 50" A.F.F. FOR EQUIPMENT USE.
- (E7) 20 AMP (CIRCUIT) 120V-1ph. WATER-PROOF DUPLEX RECEPTACLE FLUSH IN WALL 18" A.F.F. FOR OWNER PROVIDED ICE BLOCK BUILDER AND SHAVING EQUIPMENT VERIEY EXACT REQUIPMENTS WITH OWNER ICE BLOCK BUILDER AND SHAVING EQUIPMENT - VERIFY EXACT REQUIREMENTS WITH OWNER.
- E8) 14.4 AMP (LOAD) 208V-Iph. COND. CONN. DROP-DOWN FROM ABOVE FOR FREEZER COIL. ALL CONTROL WIRING BY ELECT. TRADES- FROM CONDENSER TO FREEZER COIL. ALL FINAL CONN'S BY ELECT. TRADES
- I.8 AMP (LOAD) 120V-1ph. COND. CONN. DROP-DOWN FROM ABOVE FOR REFRIGERATOR COIL. REFRIGERATOR COIL TO RUN CONTINUOUSLY.
- (EIO) 2.7 AMP (LOAD) 120V-1ph. COND. CONN. DROP-DOWN FROM ABOVE FOR REFRIGERATOR COIL.
- REFRIGERATOR COIL TO RUN CONTINUOUSLY.
- 68 AMP (TOTAL LOAD) 208V-3ph. COND. CONN. STUB-UP THRU ROOF (WATER-TIGHT) FOR REFRIGERATION RACK (#21). ALL CONTROL WIRING BY ELECT. TRADES. SEE DETAILS ON SHEETS FSE-2
- 20 AMP (CIRCUIT) 120V-1ph. WATER-PROOF QUAD RECEPTACLE FLUSH IN WALK IN WALL 18" A.F.F. PRE-WIRED BY WALK IN MANUFACTURER UP TO "J" BOX ON TOP OF WALK IN.
- (EI3) 28.7 AMP (LOAD) 208V-Iph. COND. CONN. DROP-DOWN FROM ABOVE FOR DEMAND DEFROST SEE FSE-2
- (EI4) 14.4 AMP (LOAD) 208V-Iph. COND. CONN. DROP-DOWN FROM ABOVE FOR DEMAND DEFROST SEE FSE-2

ALL ADDITIONAL RECEPTACLES, CONN.'s, WIRING, ETC. TO BE SHOWN BY ELECT. ENGINEER. ALL 120v DUPLEX RECEPTACLES WITHIN KITCHEN AREAS MUST BE GFCI PROTECTED BY ELECT. TRADES. ELECT. TRADES TO FURN. & INSTALL ALL LINE DISCONNECT SWITCHES AS REQUIRED TO MEET STATE & LOCAL CODE.



ARCHITECT OF RECORD DEMONICA KEMPER ARCHITECTS 125 N. HALSTED STREET, SUITE 301 CHICAGO, IL 60661 P: 312.496.0000

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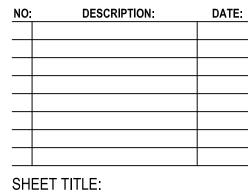
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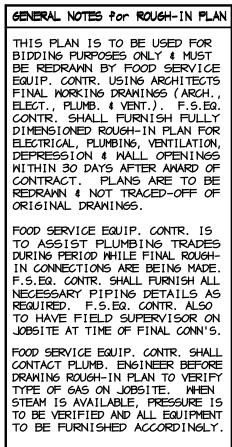
KEY PLAN:


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**FOOD SERVICE EQUIPMENT ELECTRICAL ROUGH-IN** 


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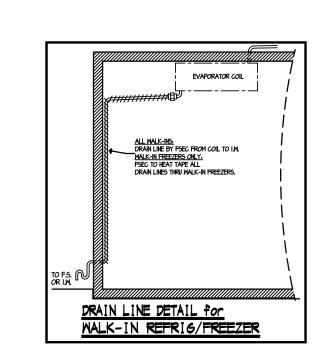





GENERAL NOTE for ROUGH-IN PLAN ALL SERVICES SHOWN WITH SYMBOLS CENTERED ON WALL SHOULD BE BROUGHT TO THAT POINT CONCEALED IN WALL & STUBBED-OUT AT HEIGHT SHOWN ON THIS PLAN OR F.S.EQ. CONTR'S FINAL DIMENSIONED ROUGH-IN PLAN. <u>DO NOT</u> STUB OUT OF FLOOR & RUN EXPOSED ON WALL.

FLOOR DRAIN SCHEDULE ALL BY <u>PLUMB. TRADES</u>- TYPICAL SIZES SHOWN. TYPE #1:6" DIA. W/ FULL NICKLE-BRONZE STRAINER. FLUSH W/ FINISH FLOOR. TYPE #2: 6" DIA. W/ FULL NICKLE-BRONZE STRAINER \$ 4" HIGH NICKLE-BRONZE FUNNEL. FLUSH W/ FINISH FLOOR. **GRATE TOP, ACID RESISTANT INTERIOR** \$ PERFORATED REMOVABLE ENAMELED BASKET FLUSH W/ FINISH FLOOR. PE #4: 12" x 12" x 10" DEEP W/ FULL ST. S REHOVABLE GRATE TOP & REHOVABLE ST. SPERFORATED BASKET.
FLUSH W/ FINISH FLOOR. INDIRECT WASTE SCHEDULE ALL BY <u>PLUMB. TRADES</u>- TYPICAL SIZES SHOWN TYPE #5: 6" DIA. N/ FULL NICKLE-BRONZE STRAINER & 4" HIGH NICKLE-BRONZE FUNNEL. <u>TYPE #6:</u> 8 1/2" DIA. N/ NHITE PORCELIN INTERIOR ( NICKLE-BRONZE INTERIOR DOME STRAINER TYPE #7: 12" x 12" x 10" DEEP <u>NO 6RATE TOP</u> W ACID RESISTANT INTERIOR & NICKLE-BRONZE INTERIOR DOME STRAINER. TYPE #8: 12" x 12" x 10" deep W 1/4 cut-out nickle-bronze grate top, acid resistant interior & nickle-bronze interior dome strainer.

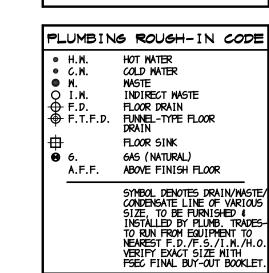

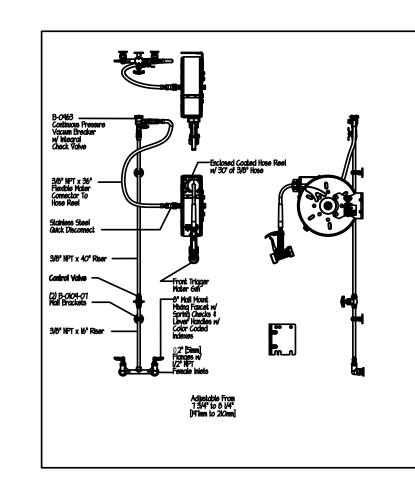


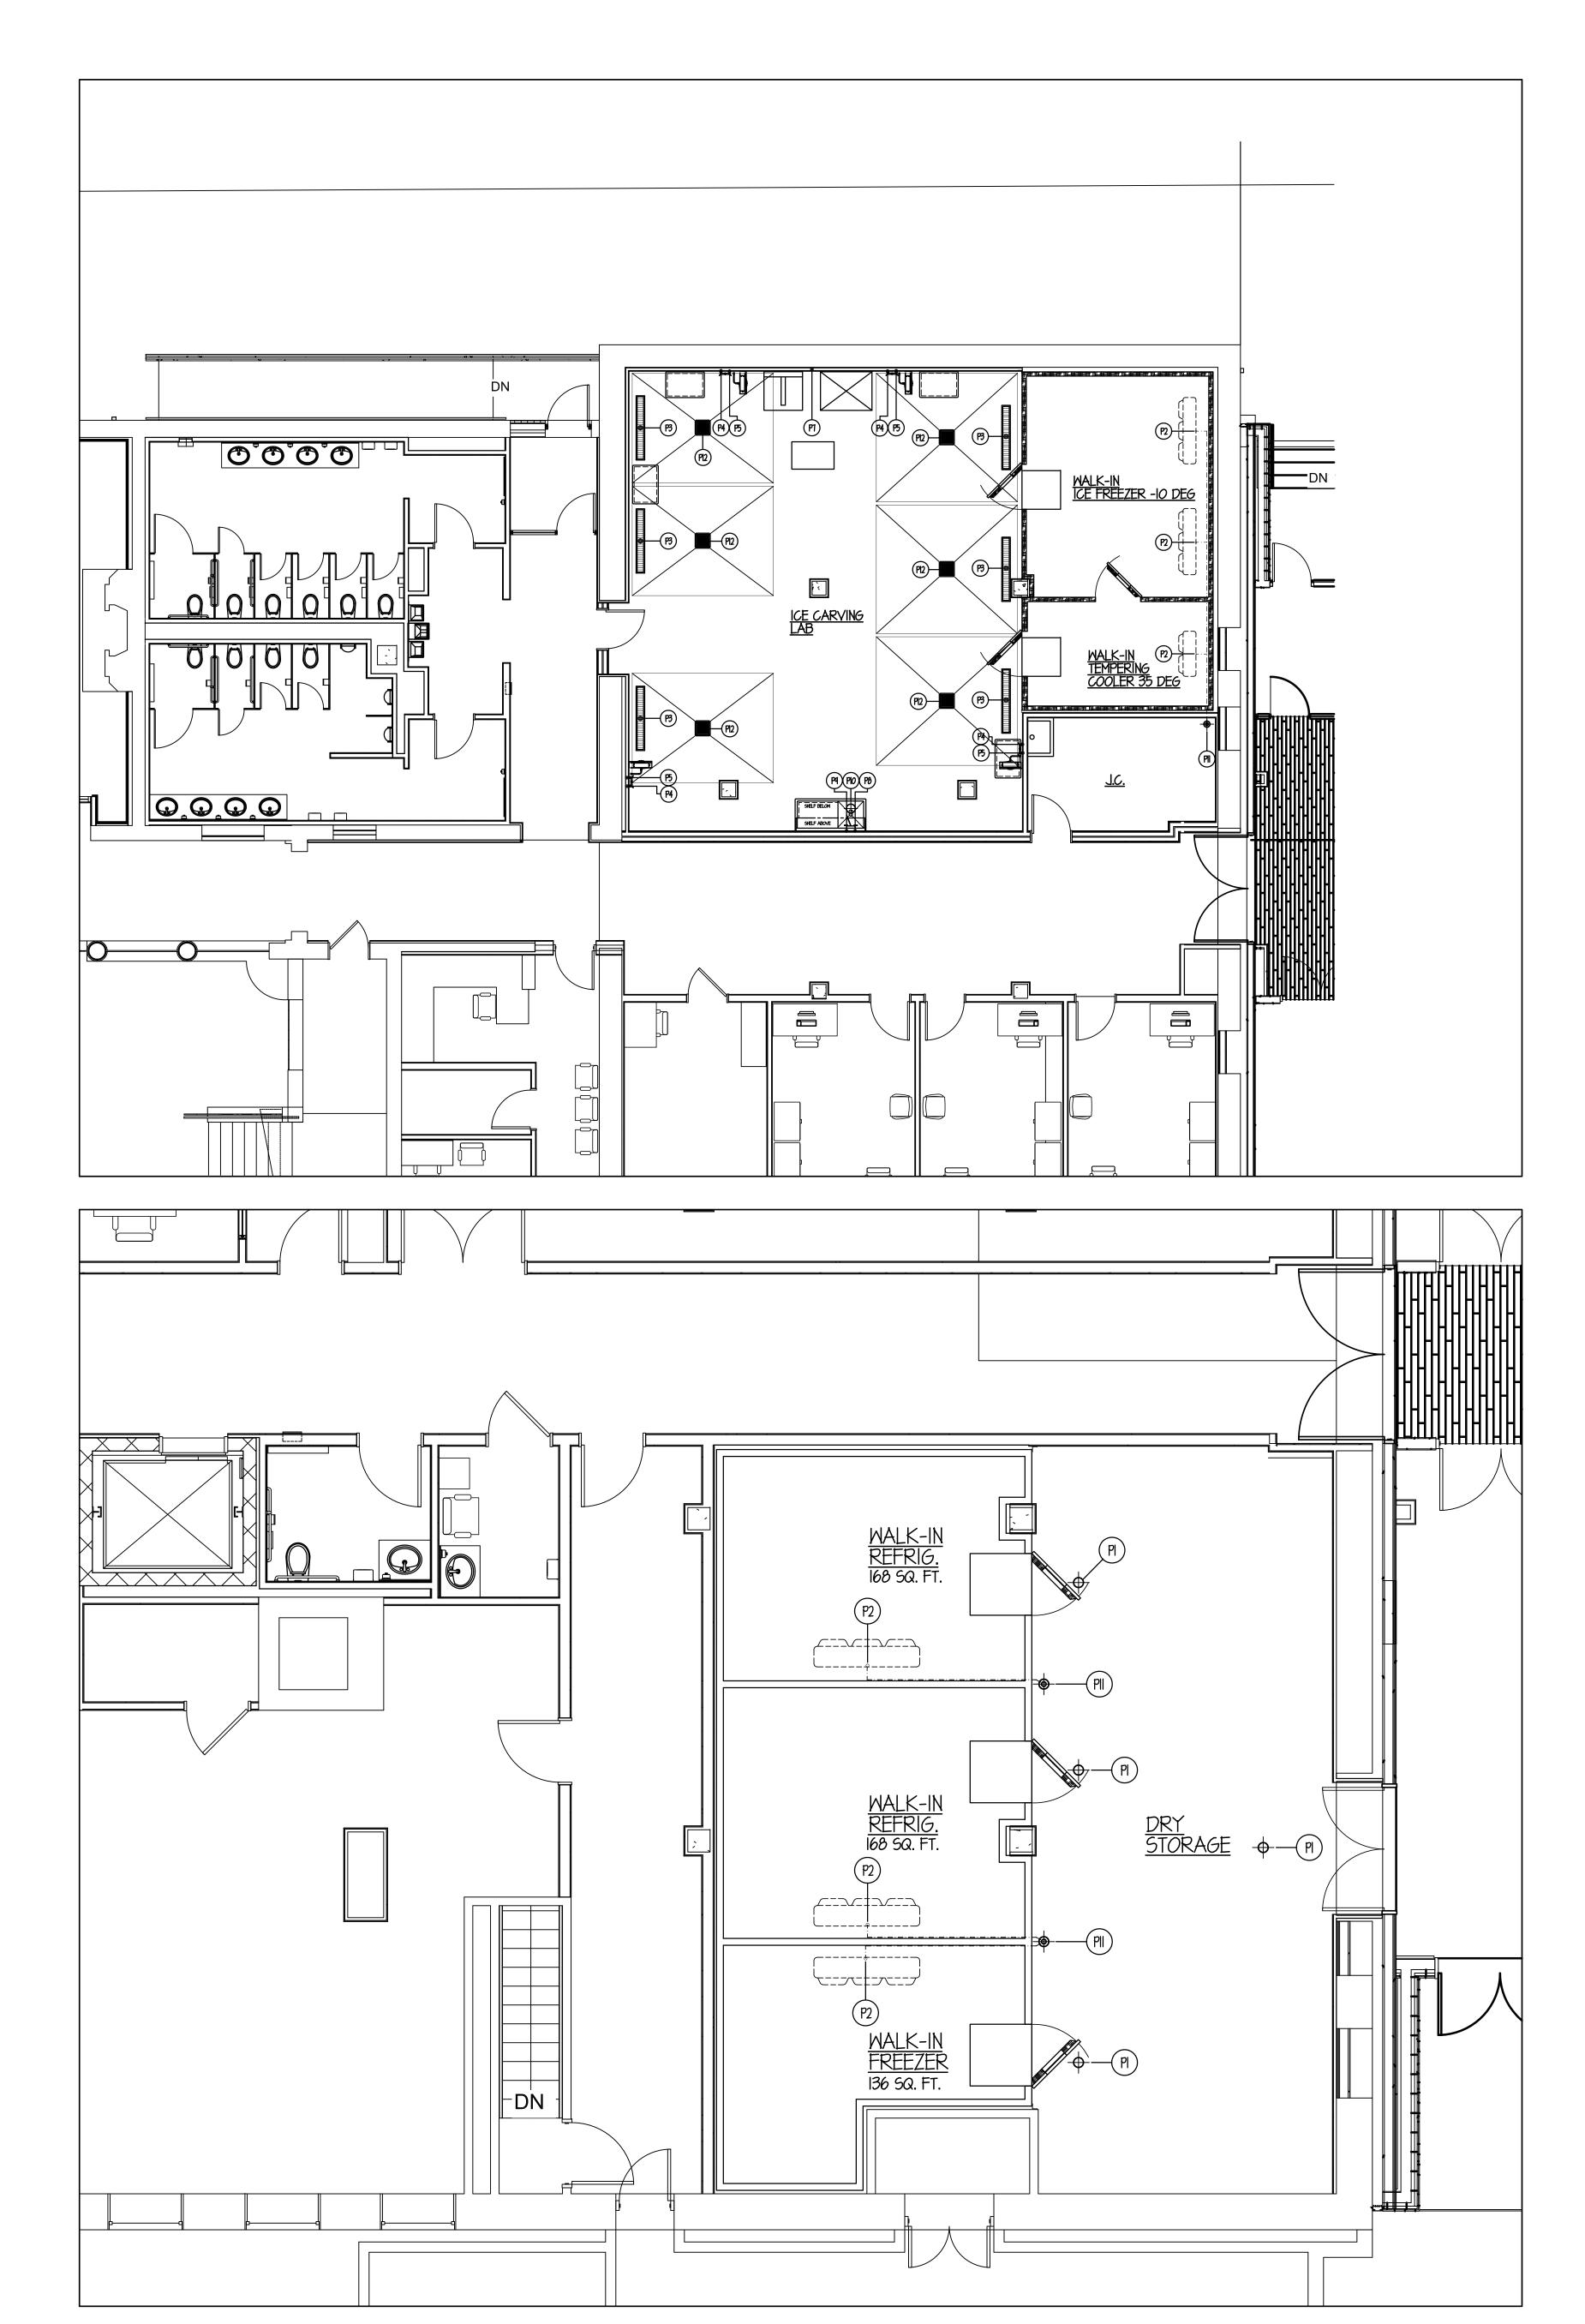

### REFRIGERATION NOTES

6" HIGH RAISED PLATFORM FURN. & INST'D BY GC - FOR REFRIGERATION RACK #21 BY FSEC APPROX. WEIGHT: 1912 LBS. SEE DETAILS ON SHEETS FSE-2

ALL REFRIGERATION LINE RUNS ARE TO BE SHOWN BY MECHANICAL ENGINEER. ALL REFRIGERATION LINES FURN. & INST'D BY FSEC (REFRIG. CONTR.)-TO BE IN THE SHORTEST, MOST EFFICIENT RUNS POSSIBLE IN FIELD. ALL REFRIGERATION LINES ABOVE FIN. CEILING TO BE RUN IN CONDUIT PER CODE. VERIFY EXACT TYPE & SIZE REQUIRED.

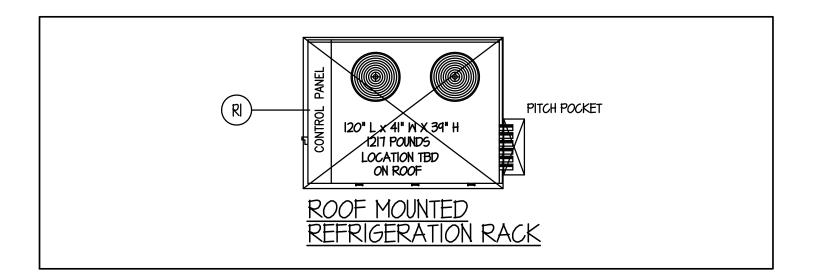

### PLUMBING NOTES

- (PI) 6" DIA. F.D.- TYPE #1. SEE SCHEDULE THIS SHEET. FLUSH W/ FIN. FLOOR.
- P2) F.S.EQ. CONTR. TO RUN DRAIN LINE FROM EACH BLOWER COIL TO I.W. OR MOP SINK NOTE... F.S.EQ. CONTR. TO HEAT TAPE ALL LINES THRU FREEZER.
- 93 3" WASTE 9" BELOW FIN. FLOOR FOR ST. ST. FLOOR DRAINER FURN. BY F.S.EQ. CONTR. & INST'D BY PLUMB. TRADES.
- (P4) 1/2" H.W. OUT OF WALL FOR HOSE REEL ASSEMBLY.
- $\left( \begin{array}{c} \mathsf{P5} \end{array} \right)$  1/2" C.W., OUT OF WALL FOR HOSE REEL ASSEMBLY.
- (P6) SPARE NOT USED
- 1/2" C.W. OUT OF WALL FOR HOSE BIB ICE BLOCK FILL
- ( P8 ) 1/2" H.W. OUT OF WALL FOR SINK FAUCET.
- (P9) 1/2" C.W. OUT OF WALL FOR SINK FAUCET.
- ( PIO) 8 I/2" DIA. I.W.- TYPE #6. SEE SCHEDULE THIS SHEET.
- 6" DIA. I.W.- TYPE #5. FUNNEL TYPE SEE SCHEDULE THIS SHEET.
- PI2) 4" WASTE 9" BELOW FIN. FLOOR FOR ST. ST. FLOOR DRAINER FURN. BY F.S.EQ. CONTR. & INST'D BY PLUMB. TRADES.

- PLUMB. TRADES TO RUN ALL DRAIN/WASTE/CONDENSATE LINES FROM EQUIPMENT TO NEAREST F.D./F.S./I.W./H.O.
- ALL ADDITIONAL PIPING, DRAINS, F.D.'s, ETC. TO BE SHOWN BY MECH. ENGINEER.
- ALL ADDITIONAL P.R.V.s, ATMOSPHERIC V.B.s, V.B.s, SHUT-OFF VALVES, SHOCK-STOPS, ETC., TO BE FURN. & INST'D BY PLUMB. TRADES.



ARCHITECT OF RECORD **DEMONICA KEMPER ARCHITECTS** 125 N. HALSTED STREET, SUITE 301 CHICAGO, IL 60661 P: 312.496.0000

STRUCTURAL & MEP/FP ENGINEERS **KJWW ENGINEERING** 1100 WARRENVILLE ROAD, #400W NAPERVILLE, IL 60563 T: 630.753.8553

FOOD SERVICE DESIGN CONSULTANTS **EF WHITNEY, INC. 568 ANN STREET** BIRMINGHAM, MI 48009

T: 248.644.0990

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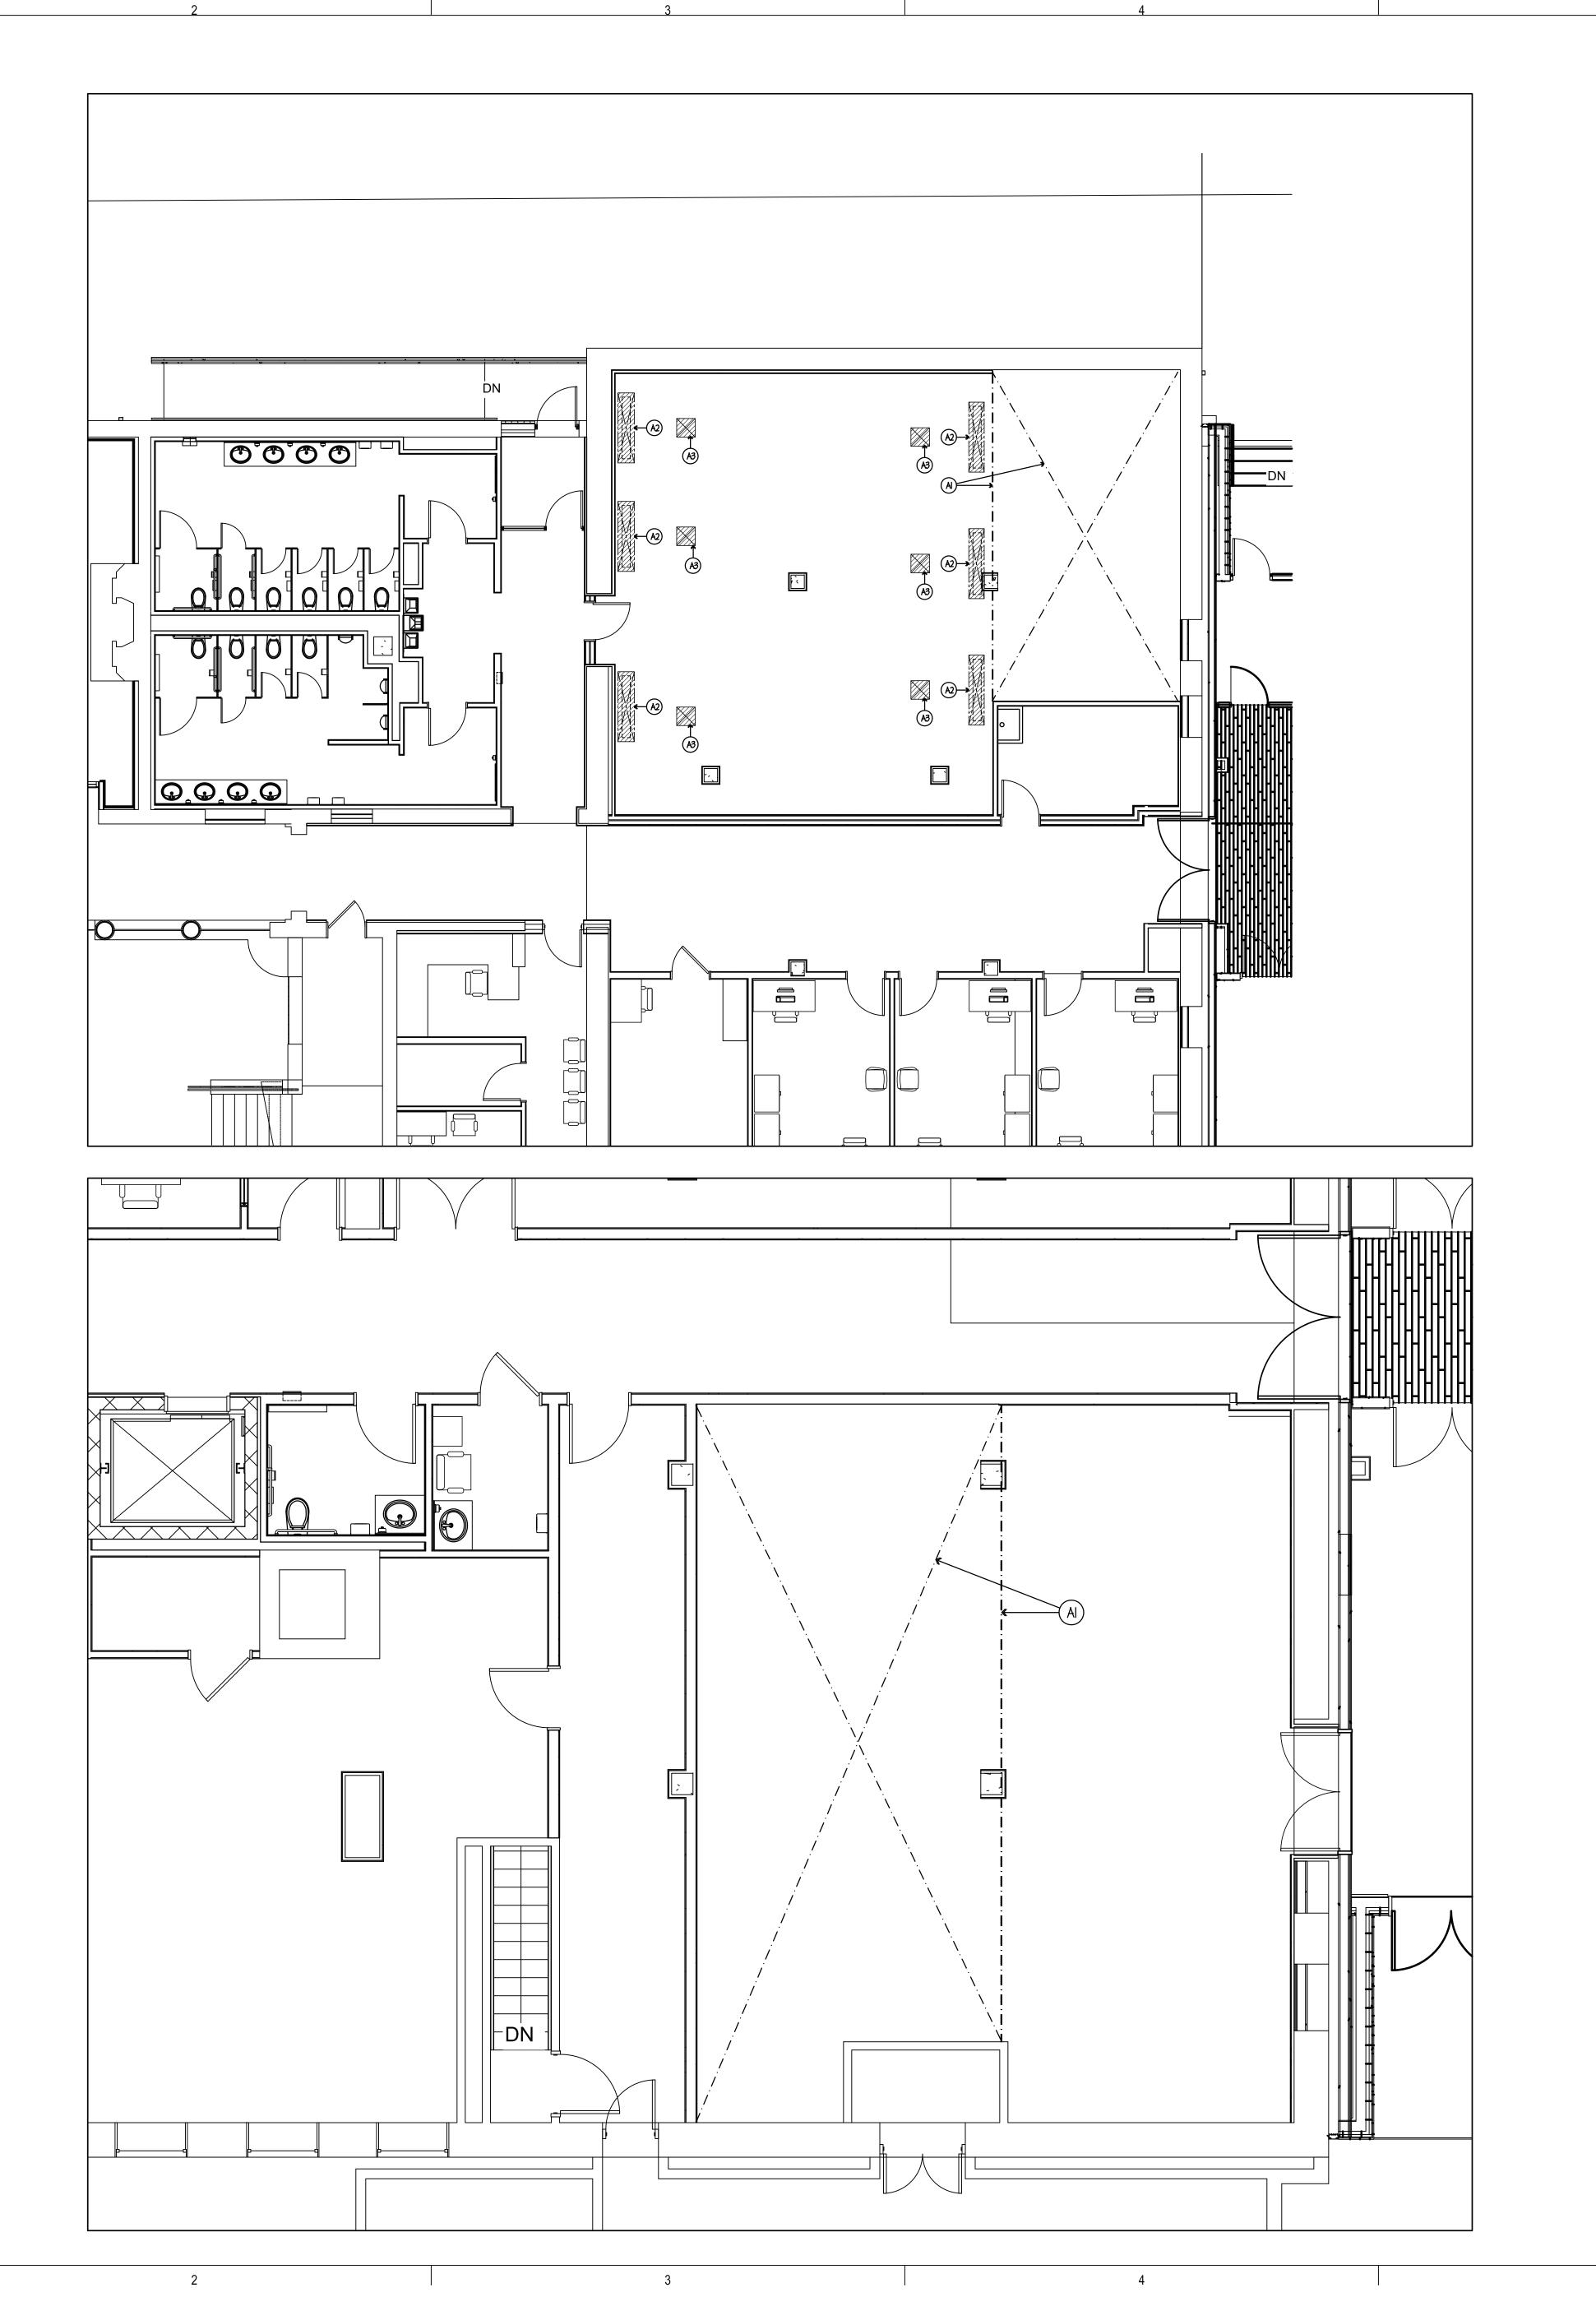
**ISSUED FOR BID** 

KEY PLAN:

NO:	DESCRIPTION:	DATE:
SHI	EET TITLE:	

**FOOD SERVICE EQUIPMENT PLUMBING ROUGH-IN** 

SHEET NUMBER:





STRUCTURAL & MEP/FP ENGINEERS

KJWW ENGINEERING

1100 WARRENVILLE ROAD, #400W

NAPERVILLE, IL 60563

T: 630.753.8553

FOOD SERVICE DESIGN CONSULTANTS
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568 ANN STREET
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# JOLIET JUNIOR COLLEGE RENAISSANCE CENTER RENOVATION

ARCHITECTURAL NOTES


(AI) BARE FLOOR THIS AREA- TO BE SMOOTH & LEVEL FOR PRE-FABRICATED INSULATED WALK IN FLOOR PANELS W INTEGRAL RAMPS

(A2) 68" W x 16" OPENING BY ARCH. TRADES THRU FIN. FLOOR FOR ST. ST. FLOOR TROUGH FURN. BY F.S.EQ. CONTR. & INST'D BY PLUMB. TRADES.

(A3) 18" W x 18" OPENING BY ARCH. TRADES THRU FIN. FLOOR FOR ST. ST. FLOOR DRAIN FURN. BY F.S.EQ. CONTR. & INST'D BY PLUMB. TRADES.

SHEET STATUS: 02/1

KEY PLAN:

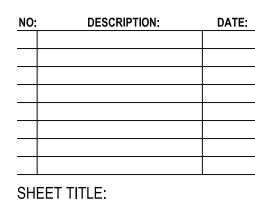

FOOD SERVICE
EQUIPMENT
FLOOR OPENING
PLAN

SHEET NUMBER: